
Woolworths Leppington Landscape Development Application 116 Ingleburn Road, Leppington

Drawing Schedule

Drawing Number	Drawing Title	Scale
000	Landscape Coversheet	N/A
001	Landscape Masterplan	1:300
002	Tree Canopy Cover	1:300
101	Landscape Plan	1:150
102	Landscape Plan	1:150
103	Landscape Plan	1:150
104	Landscape Plan	1:150
501	Landscape Details	As Shown
502	Landscape Details	As Shown
503	Landscape Details	As Shown
504	Landscape Specification	As Shown

NOT FOR CONSTRUCTION

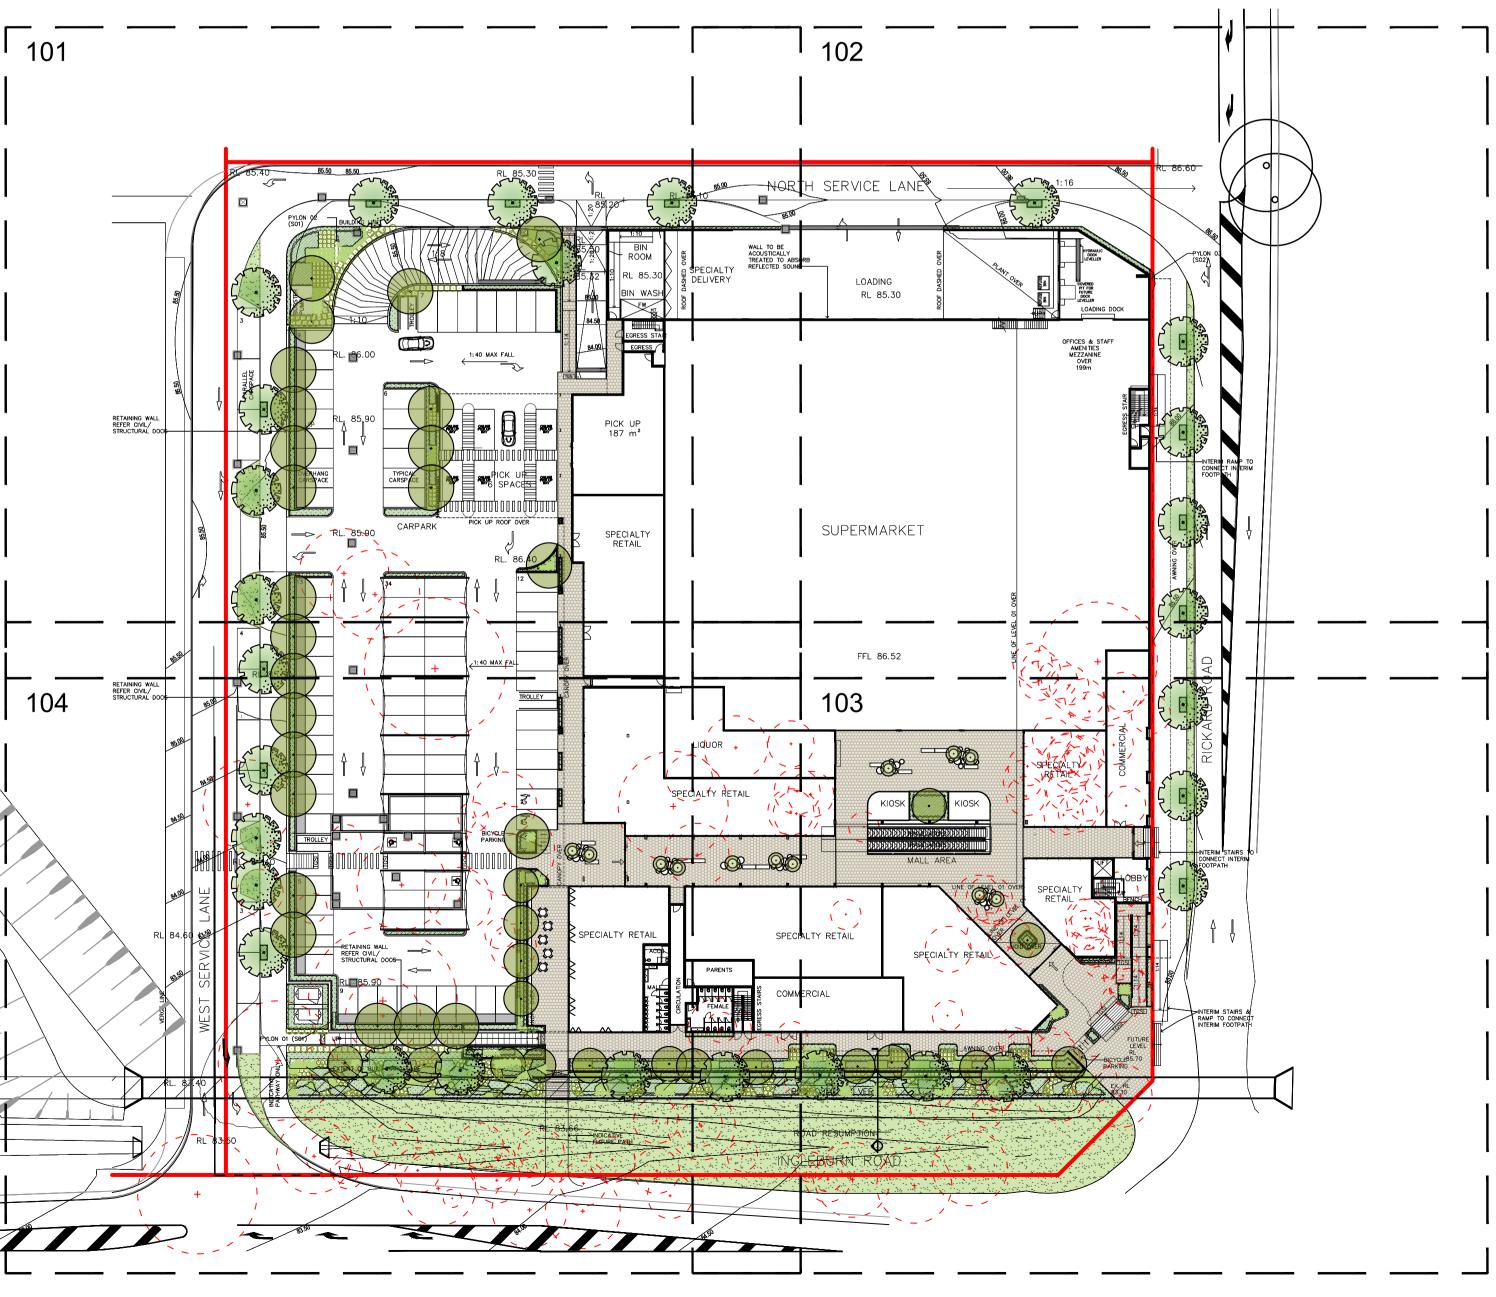

Site Plan | 1:500

© 2016 Site Image (NSW) Pty Ltd ABN 44 801 262 380 as agent for Site Image NSW Partnership. All rights reserved. This drawing is copyright and shall not be reproduced or copied in any form or by any means (graphic, electronic or mechanical including photocopy) without the written permission of Site Image (NSW) Pty Ltd Any license, expressed or implied, to use this document for any purpose what so ever is restricted to the terms of the written agreement between Site Image (NSW) Pty Ltd and the instructing party.

The contractor shall check and verify all work on site (including work by others) before commencing the landscape installation. Any discrepancies are to be reported to the Project Manager or Landscape Architect prior to commencing work. Do not scale this drawing. Any required dimensions not shown shall be referred to the Landscape Architect for confirmation.

F	Architectural Coordination	JM	NM	02.02.2021
Е	Architectural Coordination	JM	NM	13.11.2020
D	Architectural Coordination	JM	NM	24.09.2020
С	Updated Civil Drawings	SM	NM	30.03.2020
В	Architectural Coordination	JM	NM	25.03.2020
А	For Review	JM	NM	17.02.2020
Issue	Revision Description	Drawn	Check	Date

LEGEND

Client: Fabcot Pty Ltd

Project: Woolworths Leppington 116 Ingleburn Road, Leppington

Level 1, 3-5 Baptist Street Redfern NSW 2016

Australia

SITE IMAGE

Tel: (61 2) 8332 5600 Fax: (61 2) 9698 2877 www.siteimage.com.au Site Image (NSW) Pty Ltd ABN 44 801 262 380




DEVELOPMENT APPLICATION

Drawing Name: Landscape Coversheet


Scale: Job Number:

SS20-4303

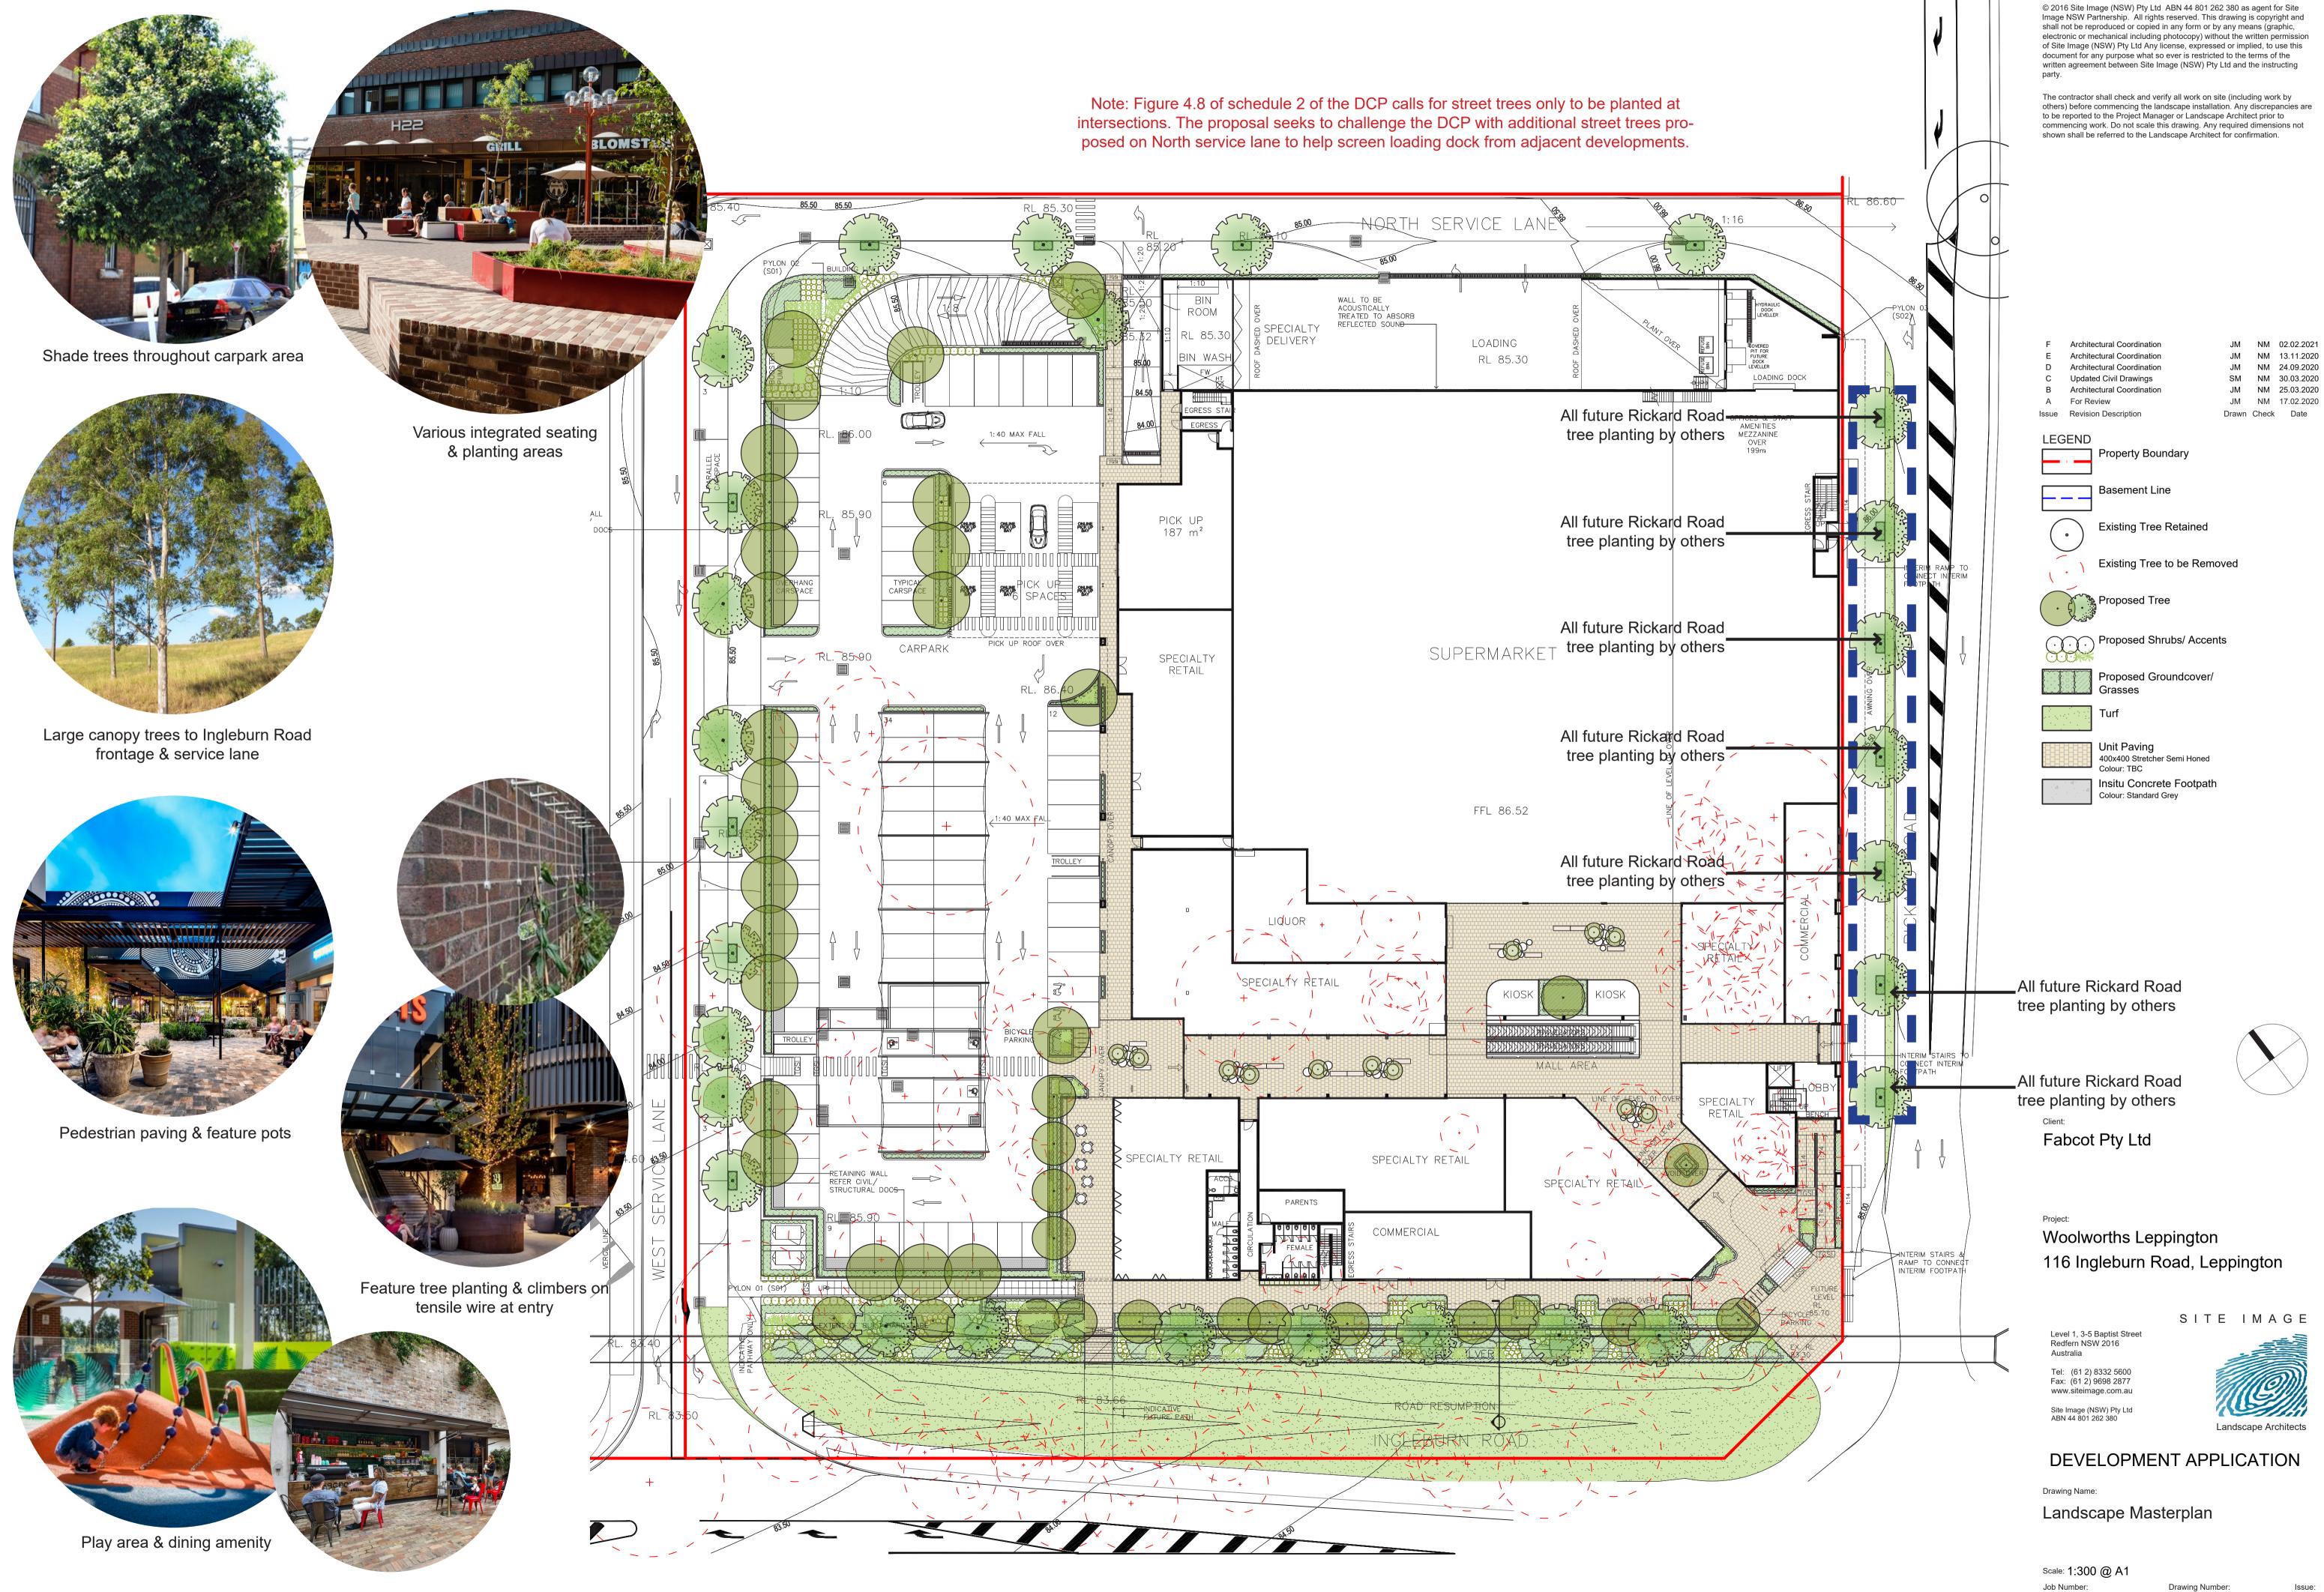

SS20-4303


Drawing Number:

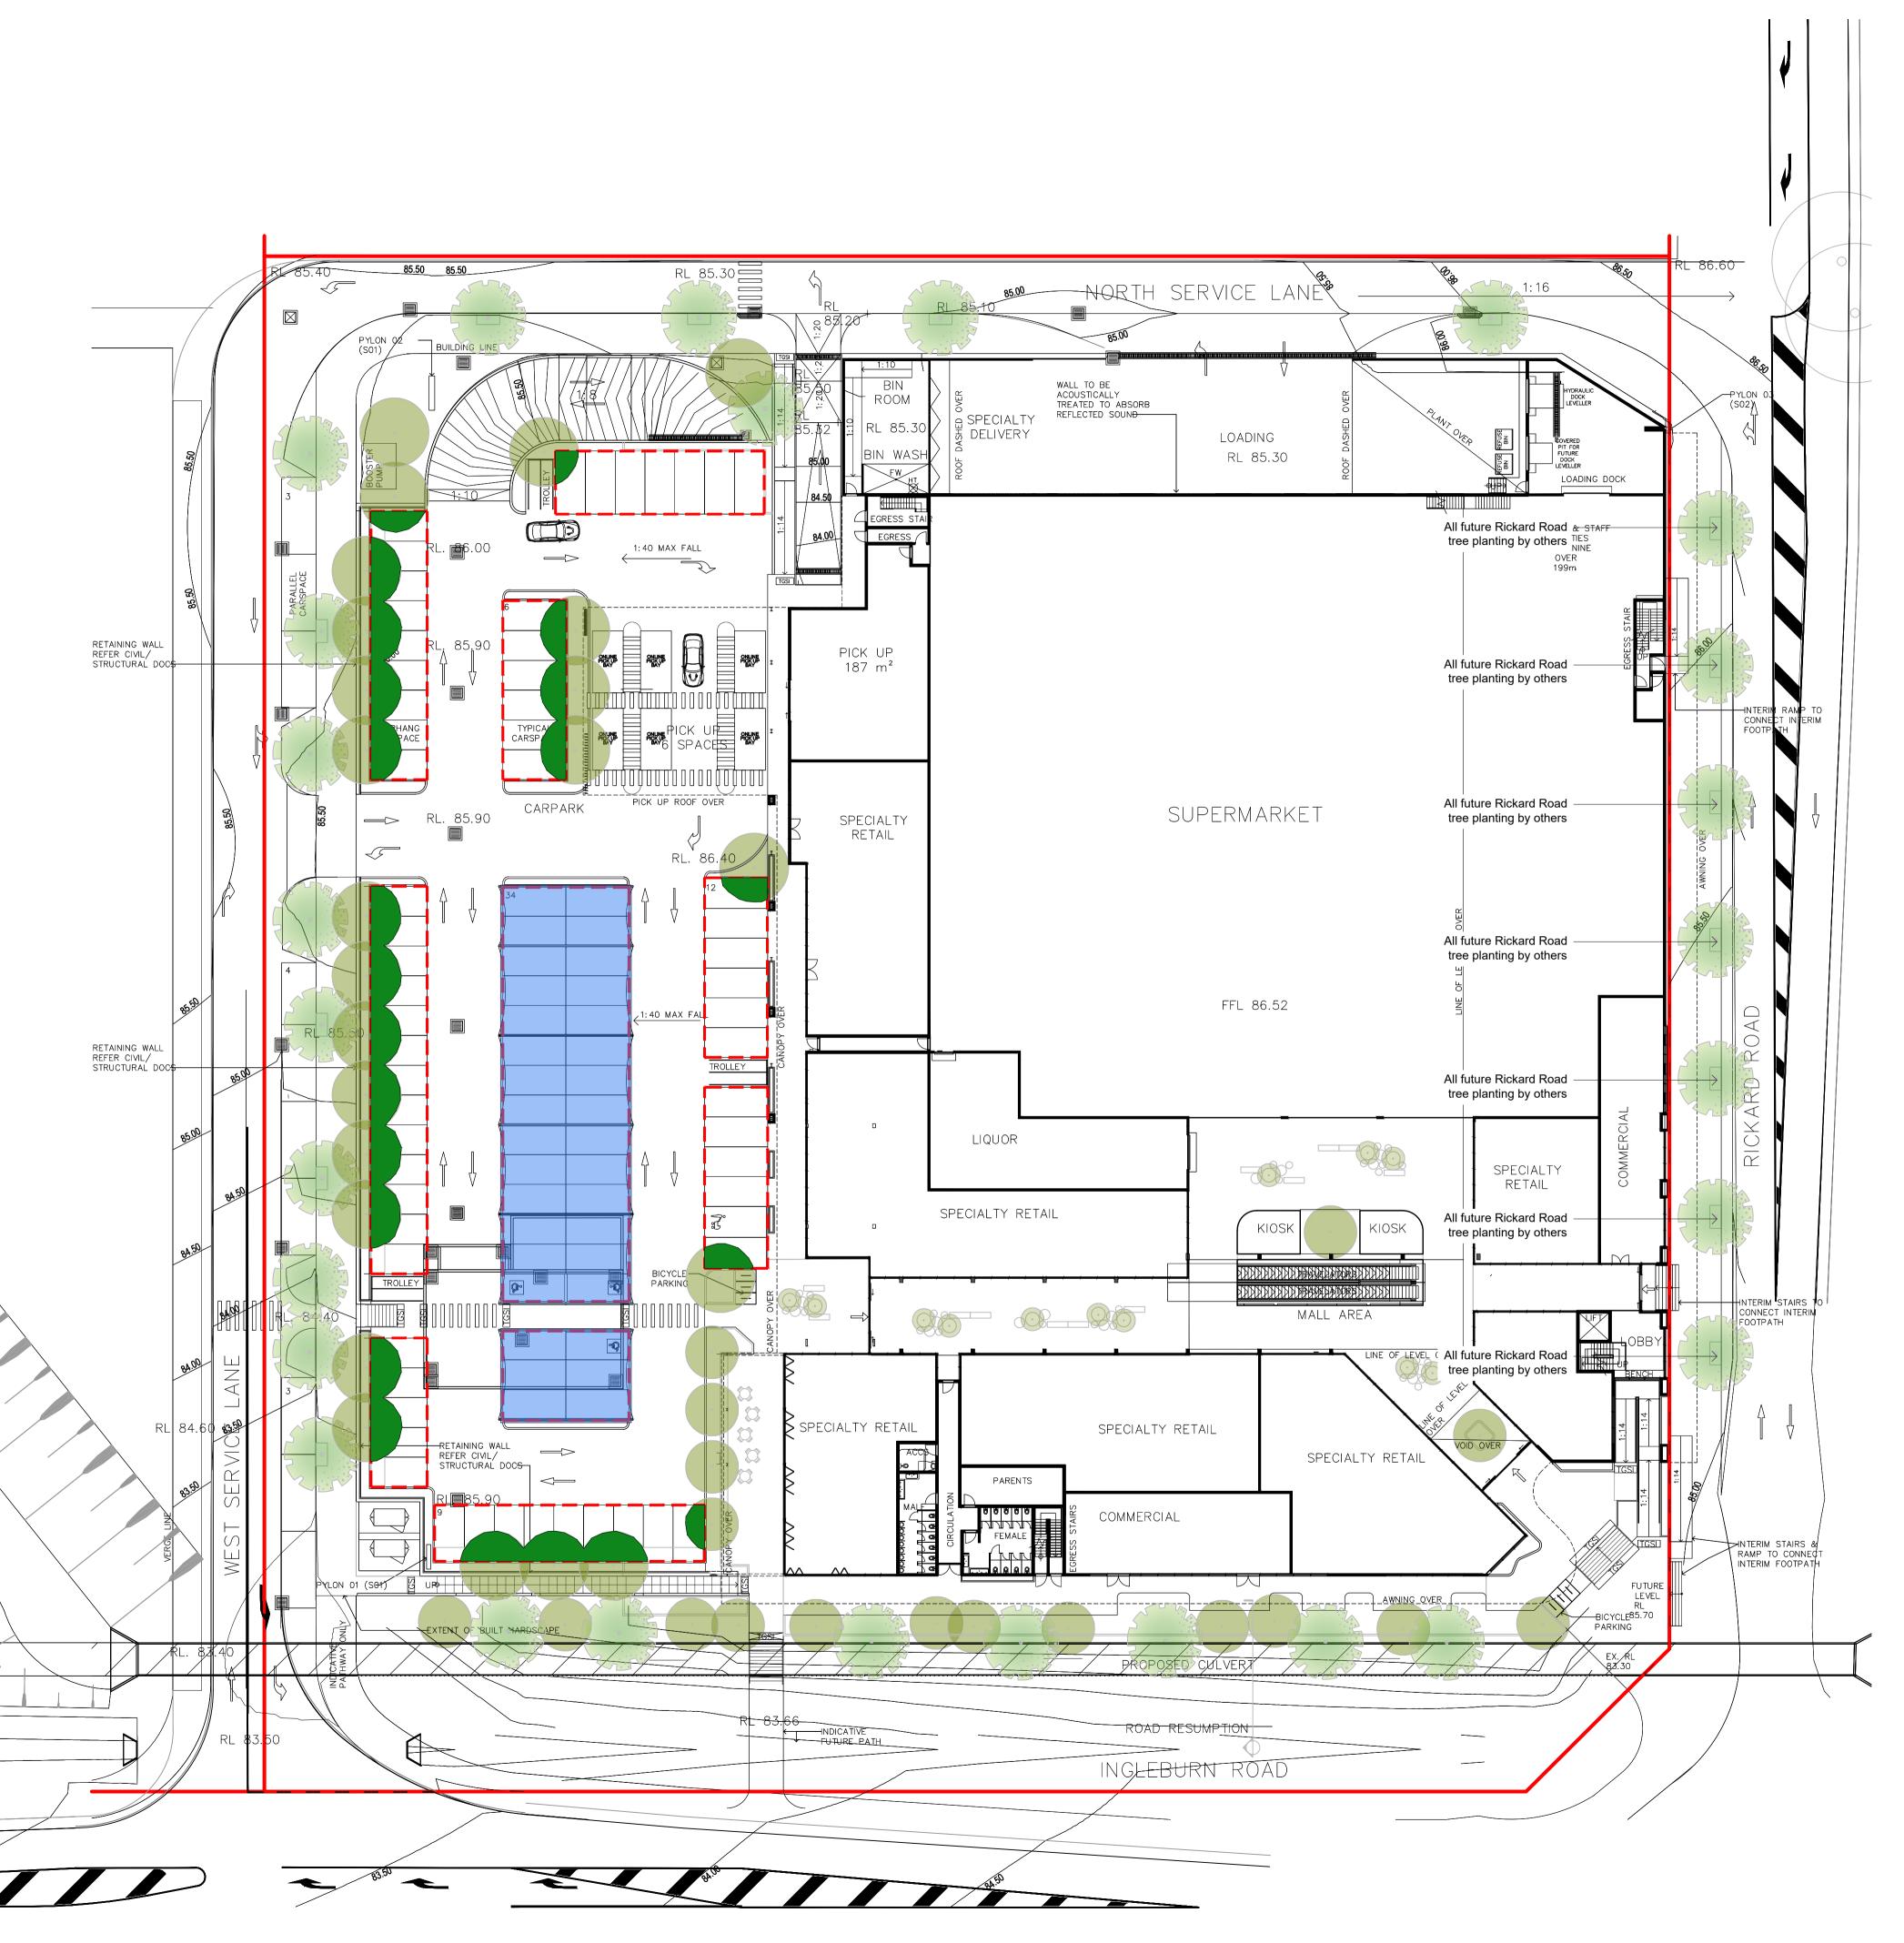

© 2016 Site Image (NSW) Pty Ltd ABN 44 801 262 380 as agent for Site Image NSW Partnership. All rights reserved. This drawing is copyright and shall not be reproduced or copied in any form or by any means (graphic, electronic or mechanical including photocopy) without the written permission of Site Image (NSW) Pty Ltd Any license, expressed or implied, to use this document for any purpose what so ever is restricted to the terms of the written agreement between Site Image (NSW) Pty Ltd and the instructing party.

The contractor shall check and verify all work on site (including work by others) before commencing the landscape installation. Any discrepancies are to be reported to the Project Manager or Landscape Architect prior to commencing work. Do not scale this drawing. Any required dimensions not shown shall be referred to the Landscape Architect for confirmation.


F	Architectural Coordination	JM	NM	02.02.2021	
Е	Architectural Coordination	JM	NM	13.11.2020	
D	Architectural Coordination	JM	NM	24.09.2020	
С	Updated Civil Drawings	SM	NM	30.03.2020	
В	Architectural Coordination	JM	NM	25.03.2020	
А	For Review	JM	NM	17.02.2020	
Issue	Revision Description	Drawn	Check	Date	

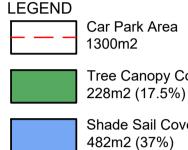

Tree Canopy Cover 228m2 (17.5%)

Shade Sail Cover 482m2 (37%)

Total Shade Cover 710m2 (54.5%)

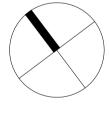

Client: Fabcot Pty Ltd

Project: Woolworths Leppington 116 Ingleburn Road, Leppington

Level 1, 3-5 Baptist Street Redfern NSW 2016

Australia

SITE IMAGE

Tel: (61 2) 8332 5600 Fax: (61 2) 9698 2877 www.siteimage.com.au Site Image (NSW) Pty Ltd ABN 44 801 262 380



DEVELOPMENT APPLICATION


Drawing Number:

Drawing Name:

Carpark Tree Canopy Cover


Scale: 1:300 @ A1 Job Number:

SS20-4303

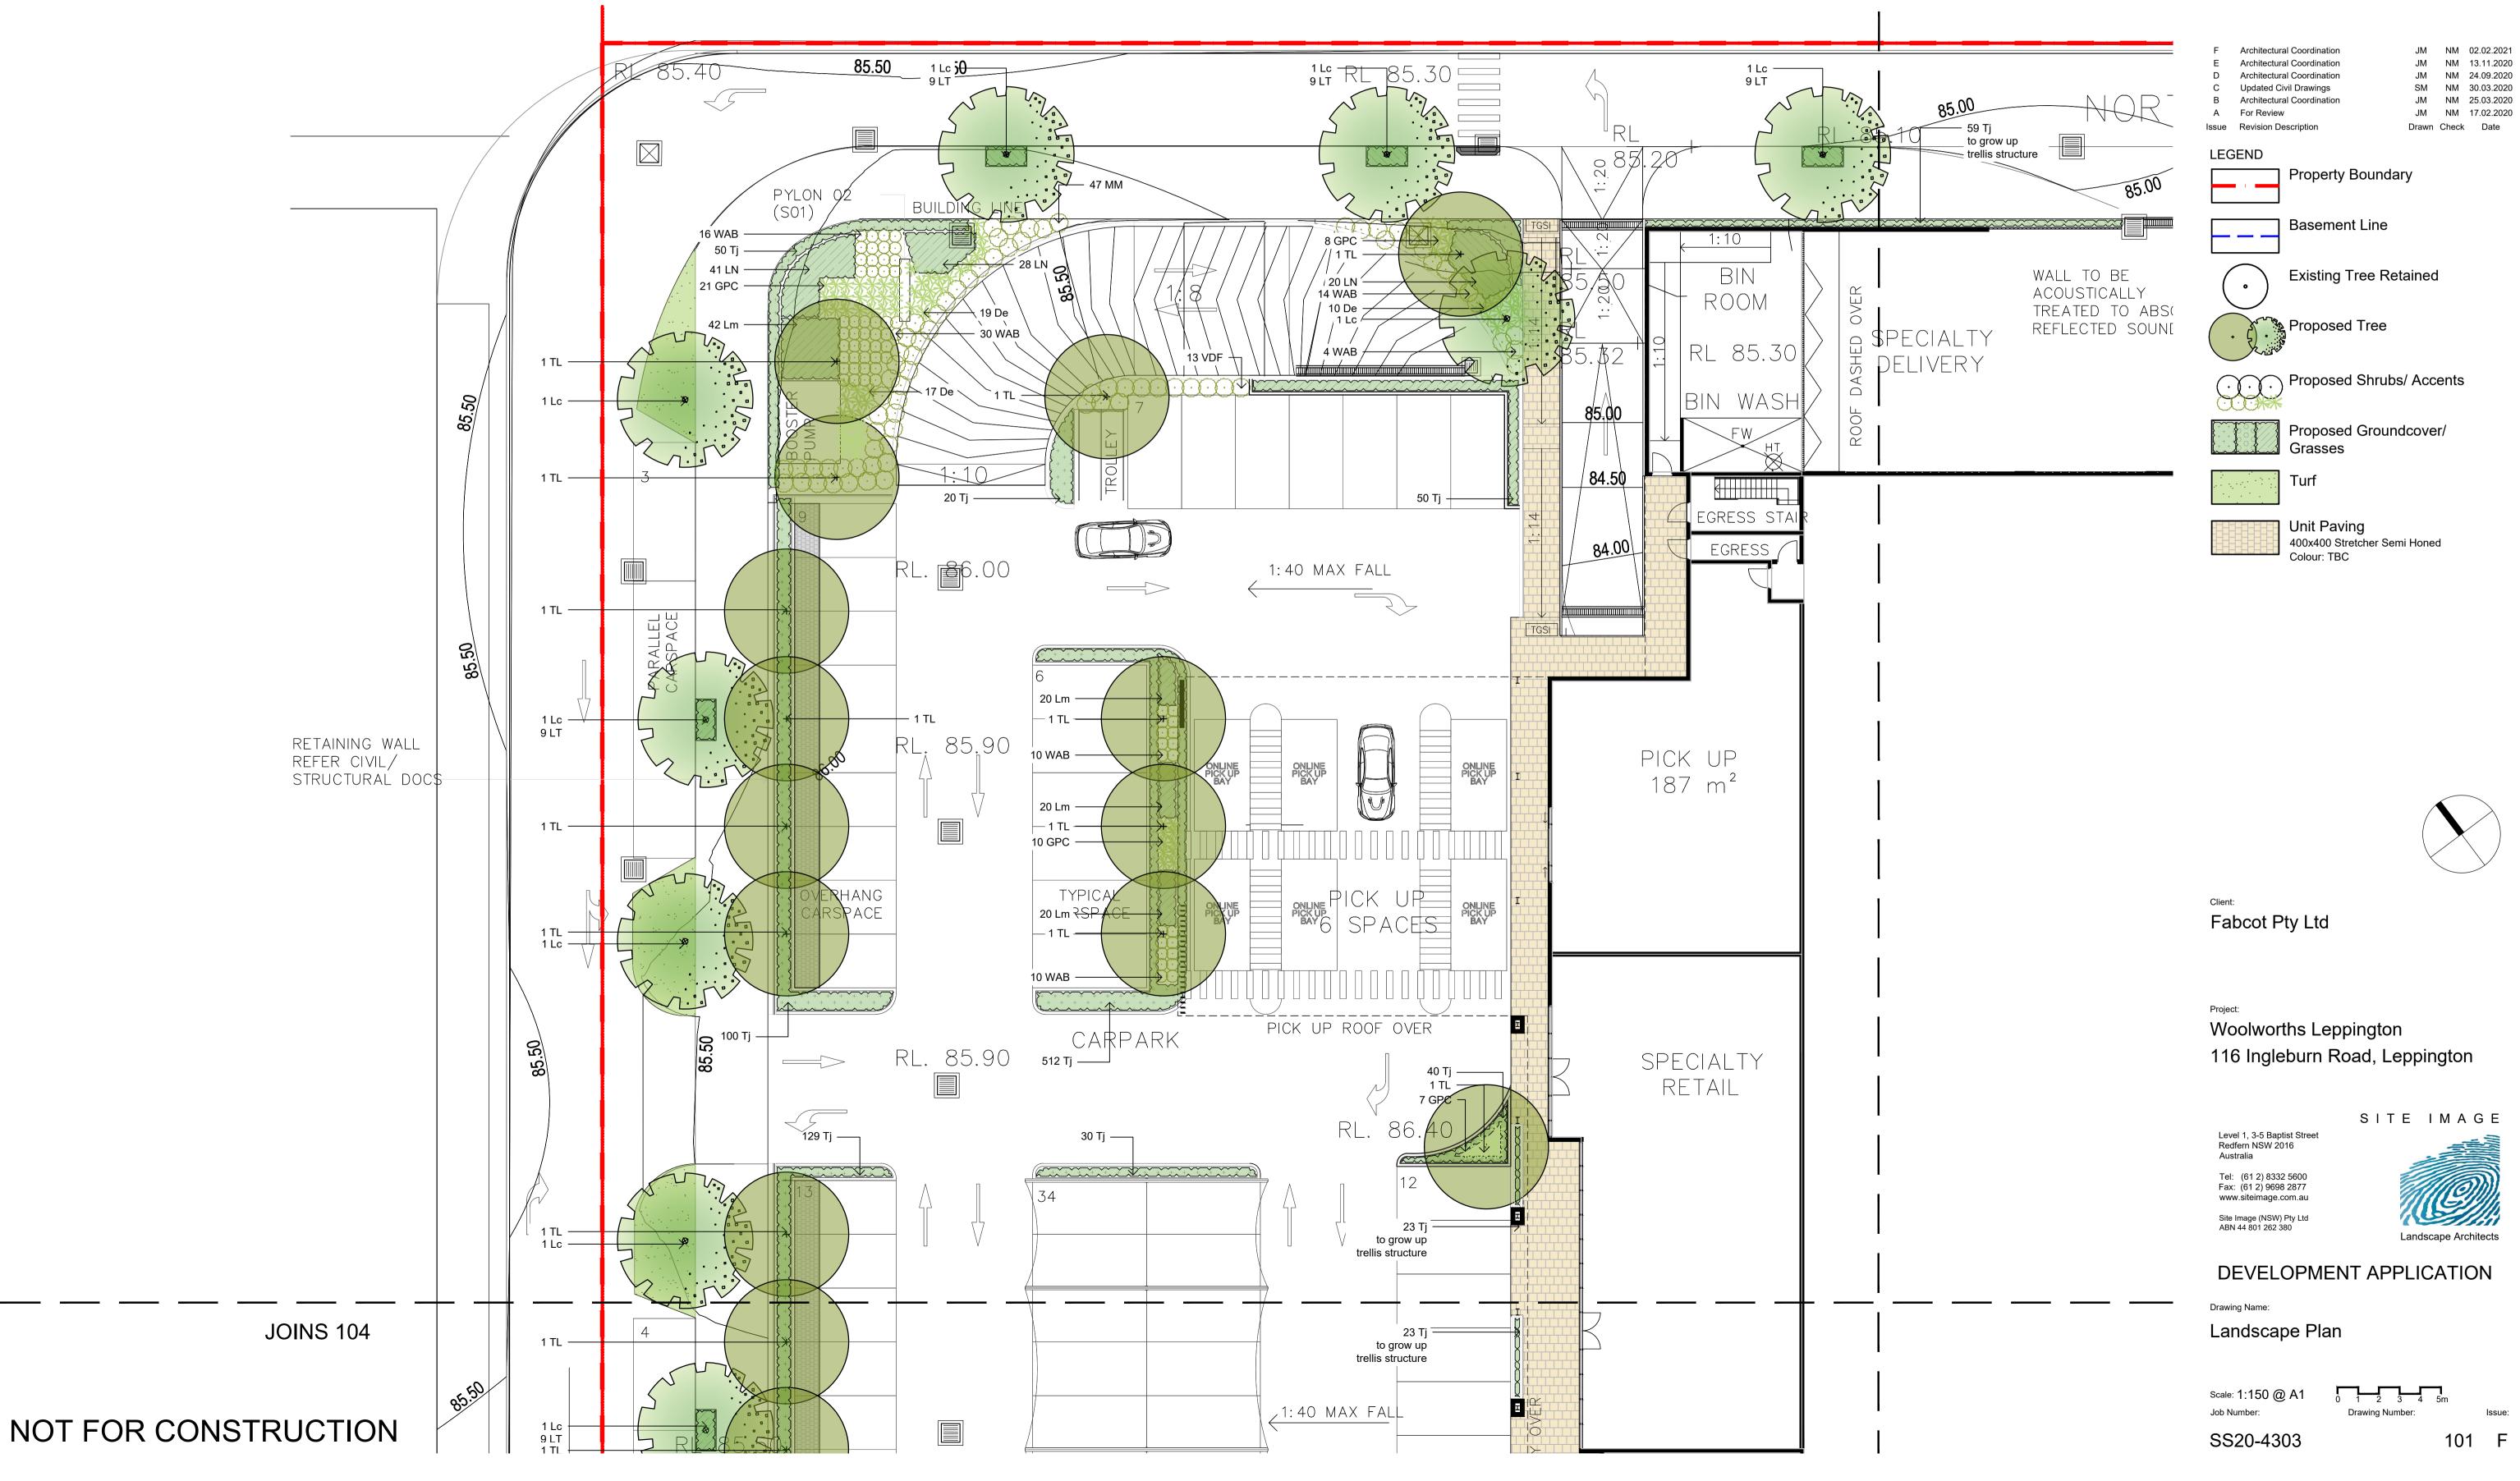

© 2016 Site Image (NSW) Pty Ltd ABN 44 801 262 380 as agent for Site Image NSW Partnership. All rights reserved. This drawing is copyright and shall not be reproduced or copied in any form or by any means (graphic, electronic or mechanical including photocopy) without the written permission of Site Image (NSW) Pty Ltd Any license, expressed or implied, to use this document for any purpose what so ever is restricted to the terms of the written agreement between Site Image (NSW) Pty Ltd and the instructing party.

The contractor shall check and verify all work on site (including work by others) before commencing the landscape installation. Any discrepancies are to be reported to the Project Manager or Landscape Architect prior to commencing work. Do not scale this drawing. Any required dimensions not shown shall be referred to the Landscape Architect for confirmation.

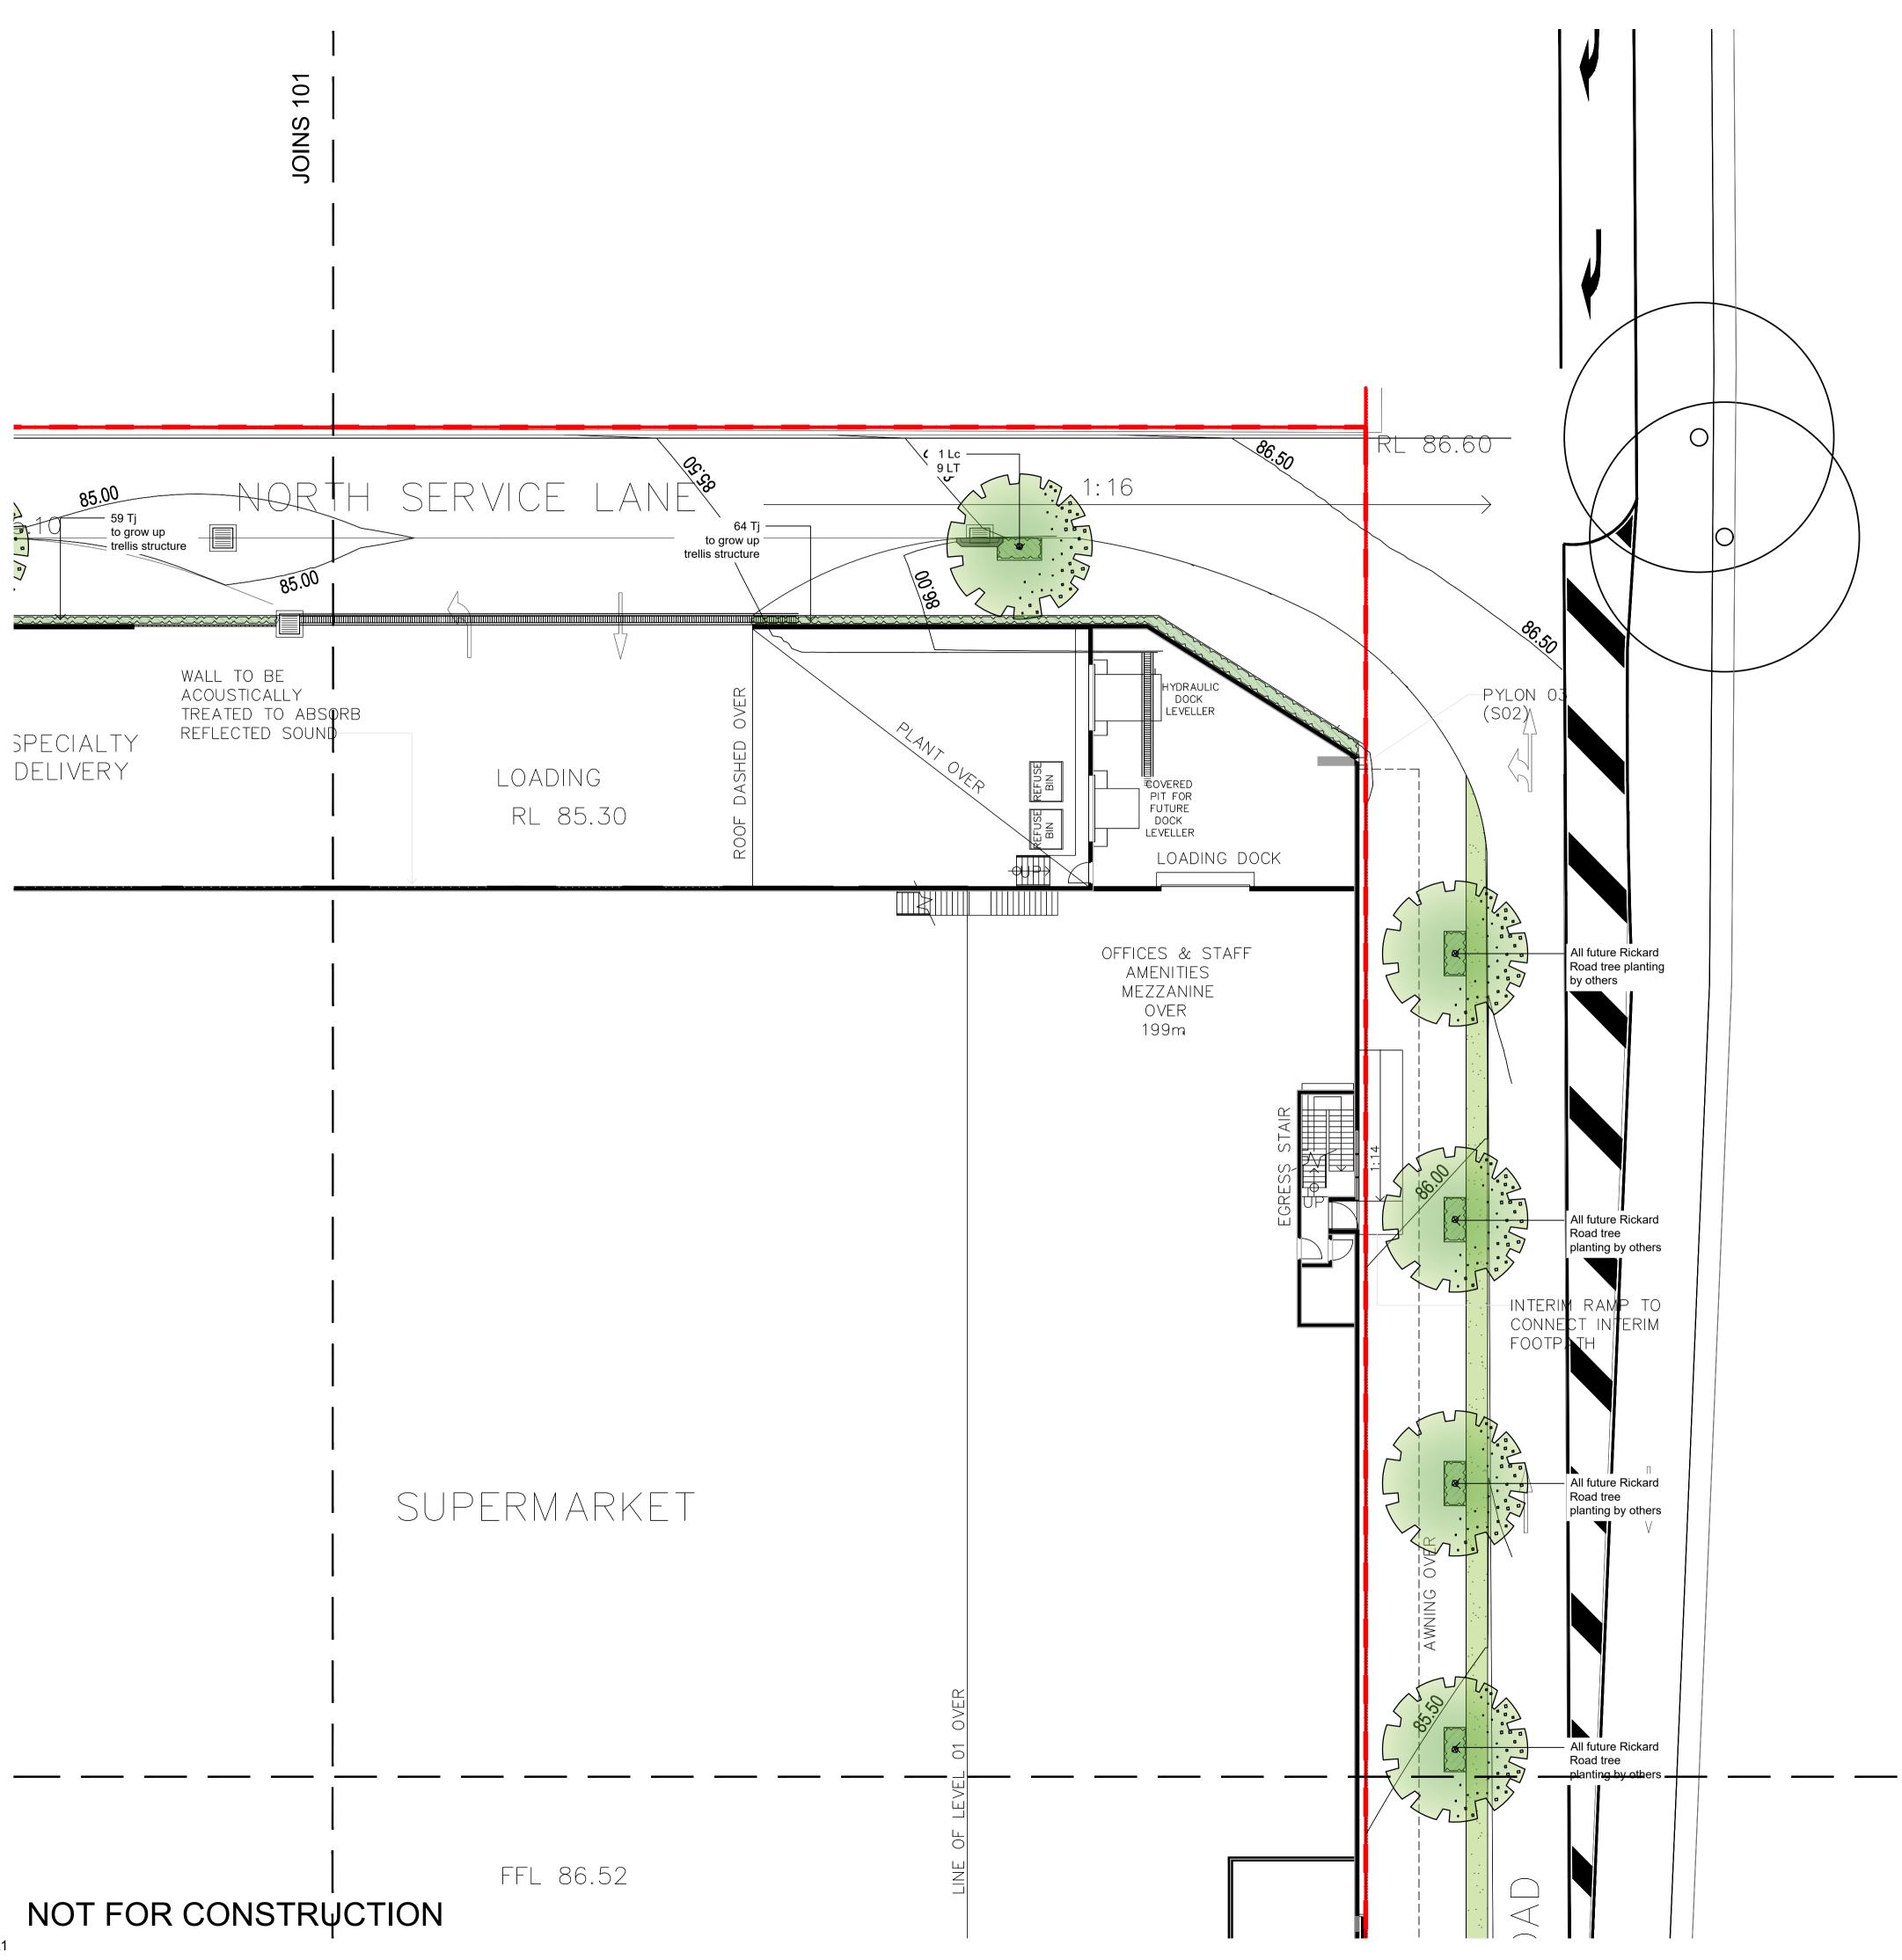

 $\textcircled{\sc 0}$ 2016 Site Image (NSW) Pty Ltd ABN 44 801 262 380 as agent for Site Image NSW Partnership. All rights reserved. This drawing is copyright and shall not be reproduced or copied in any form or by any means (graphic, electronic or mechanical including photocopy) without the written permission of Site Image (NSW) Pty Ltd Any license, expressed or implied, to use this document for any purpose what so ever is restricted to the terms of the written agreement between Site Image (NSW) Pty Ltd and the instructing party.

The contractor shall check and verify all work on site (including work by others) before commencing the landscape installation. Any discrepancies are to be reported to the Project Manager or Landscape Architect prior to commencing work. Do not scale this drawing. Any required dimensions not shown shall be referred to the Landscape Architect for confirmation.

F Architectural Coordination JM NM 02.02.2021 JM NM 13.11.2020 Architectural Coordination Architectural Coordination JM NM 24.09.2020 Updated Civil Drawings SM NM 30.03.2020 С B Architectural Coordination JM NM 25.03.2020 A For Review JM NM 17.02.2020 Issue Revision Description Drawn Check Date

LEGEND

Property Boundary



Existing Tree Retained

Ripposed Tree

Proposed Shrubs/ Accents

Proposed Groundcover/ Grasses

Turf

Unit Paving 400x400 Stretcher Semi Honed Colour: TBC

Client: Fabcot Pty Ltd

Project: Woolworths Leppington 116 Ingleburn Road, Leppington

Level 1, 3-5 Baptist Street Redfern NSW 2016

Australia

SITE IMAGE

Tel: (61 2) 8332 5600 Fax: (61 2) 9698 2877 www.siteimage.com.au Site Image (NSW) Pty Ltd ABN 44 801 262 380




Landscape Architects

Issue


DEVELOPMENT APPLICATION


Drawing Name: Landscape Plan


Scale: 1:150 @ A1 Job Number:

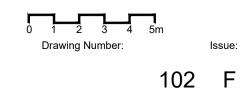

SS20-4303

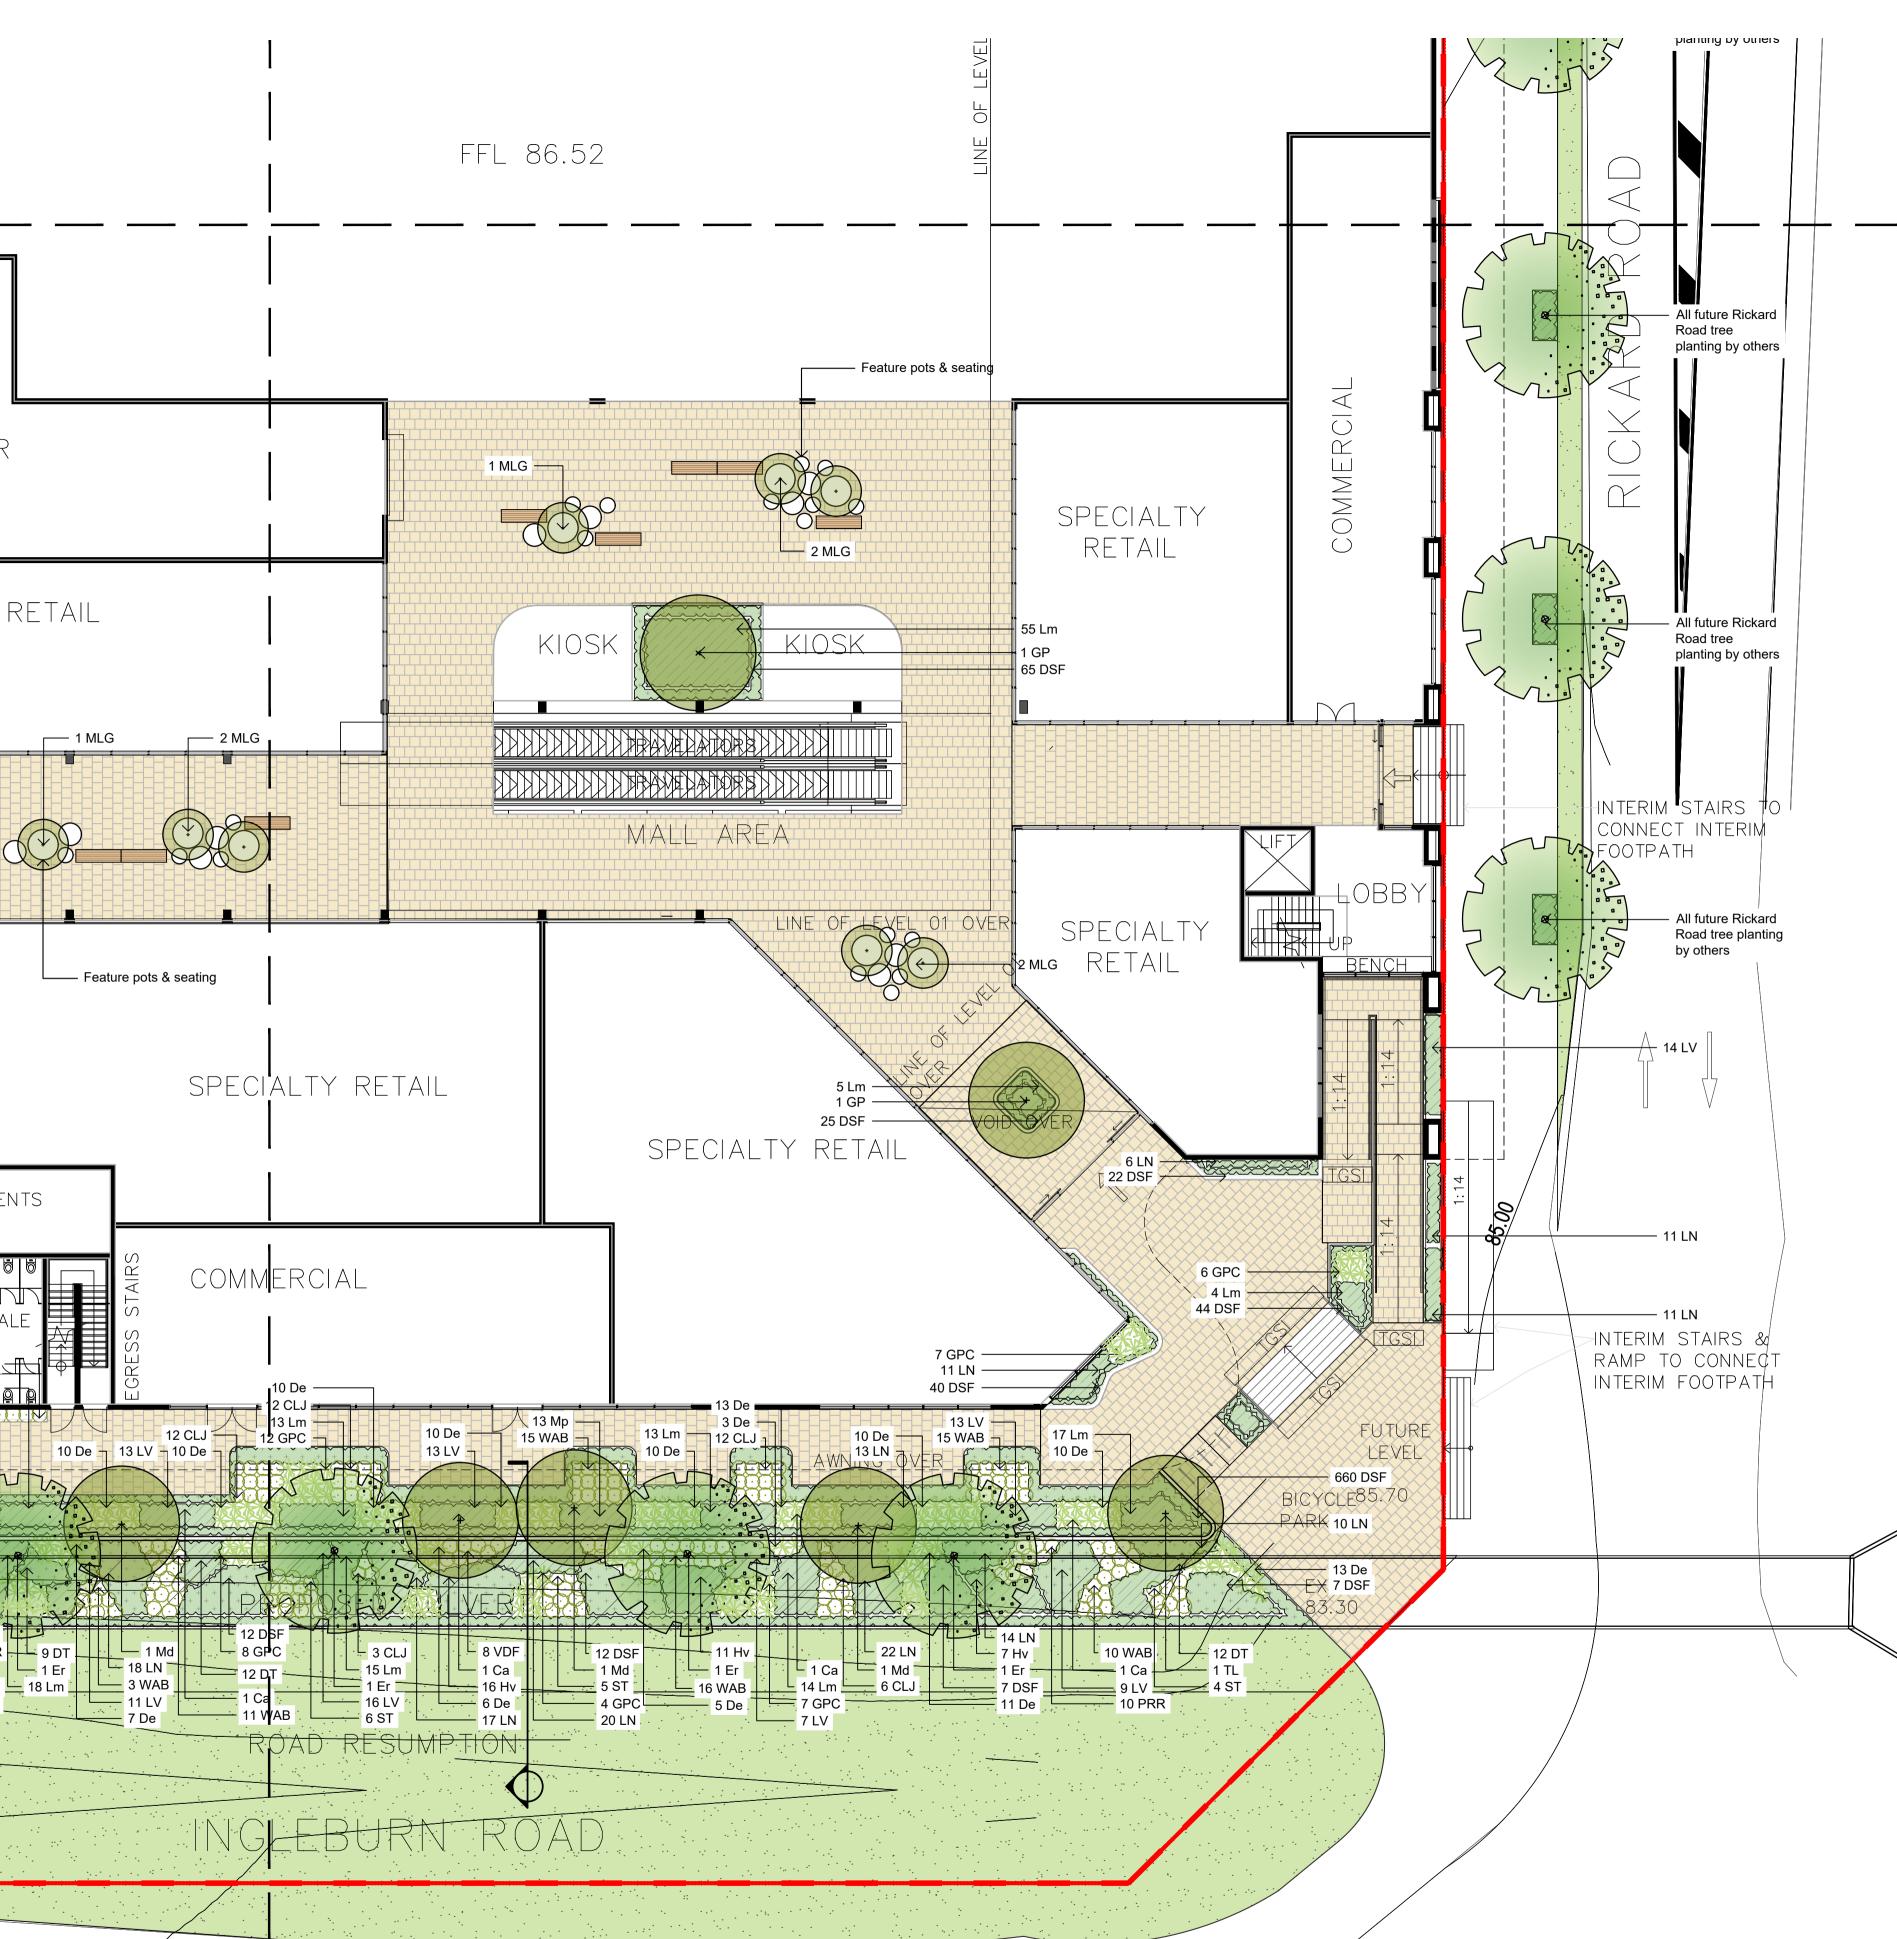

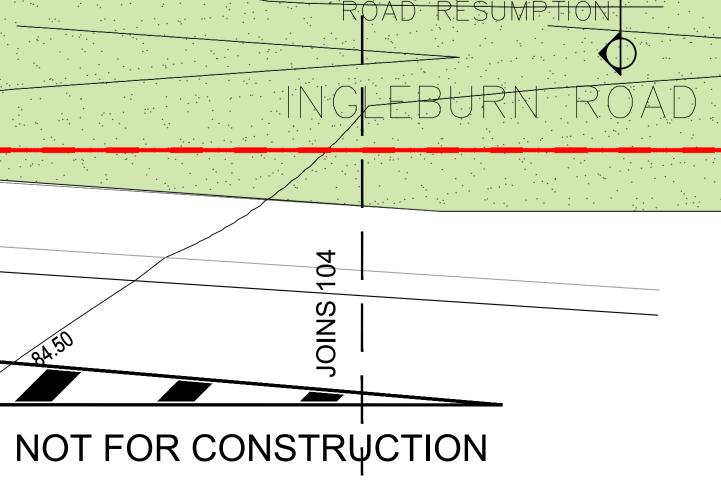

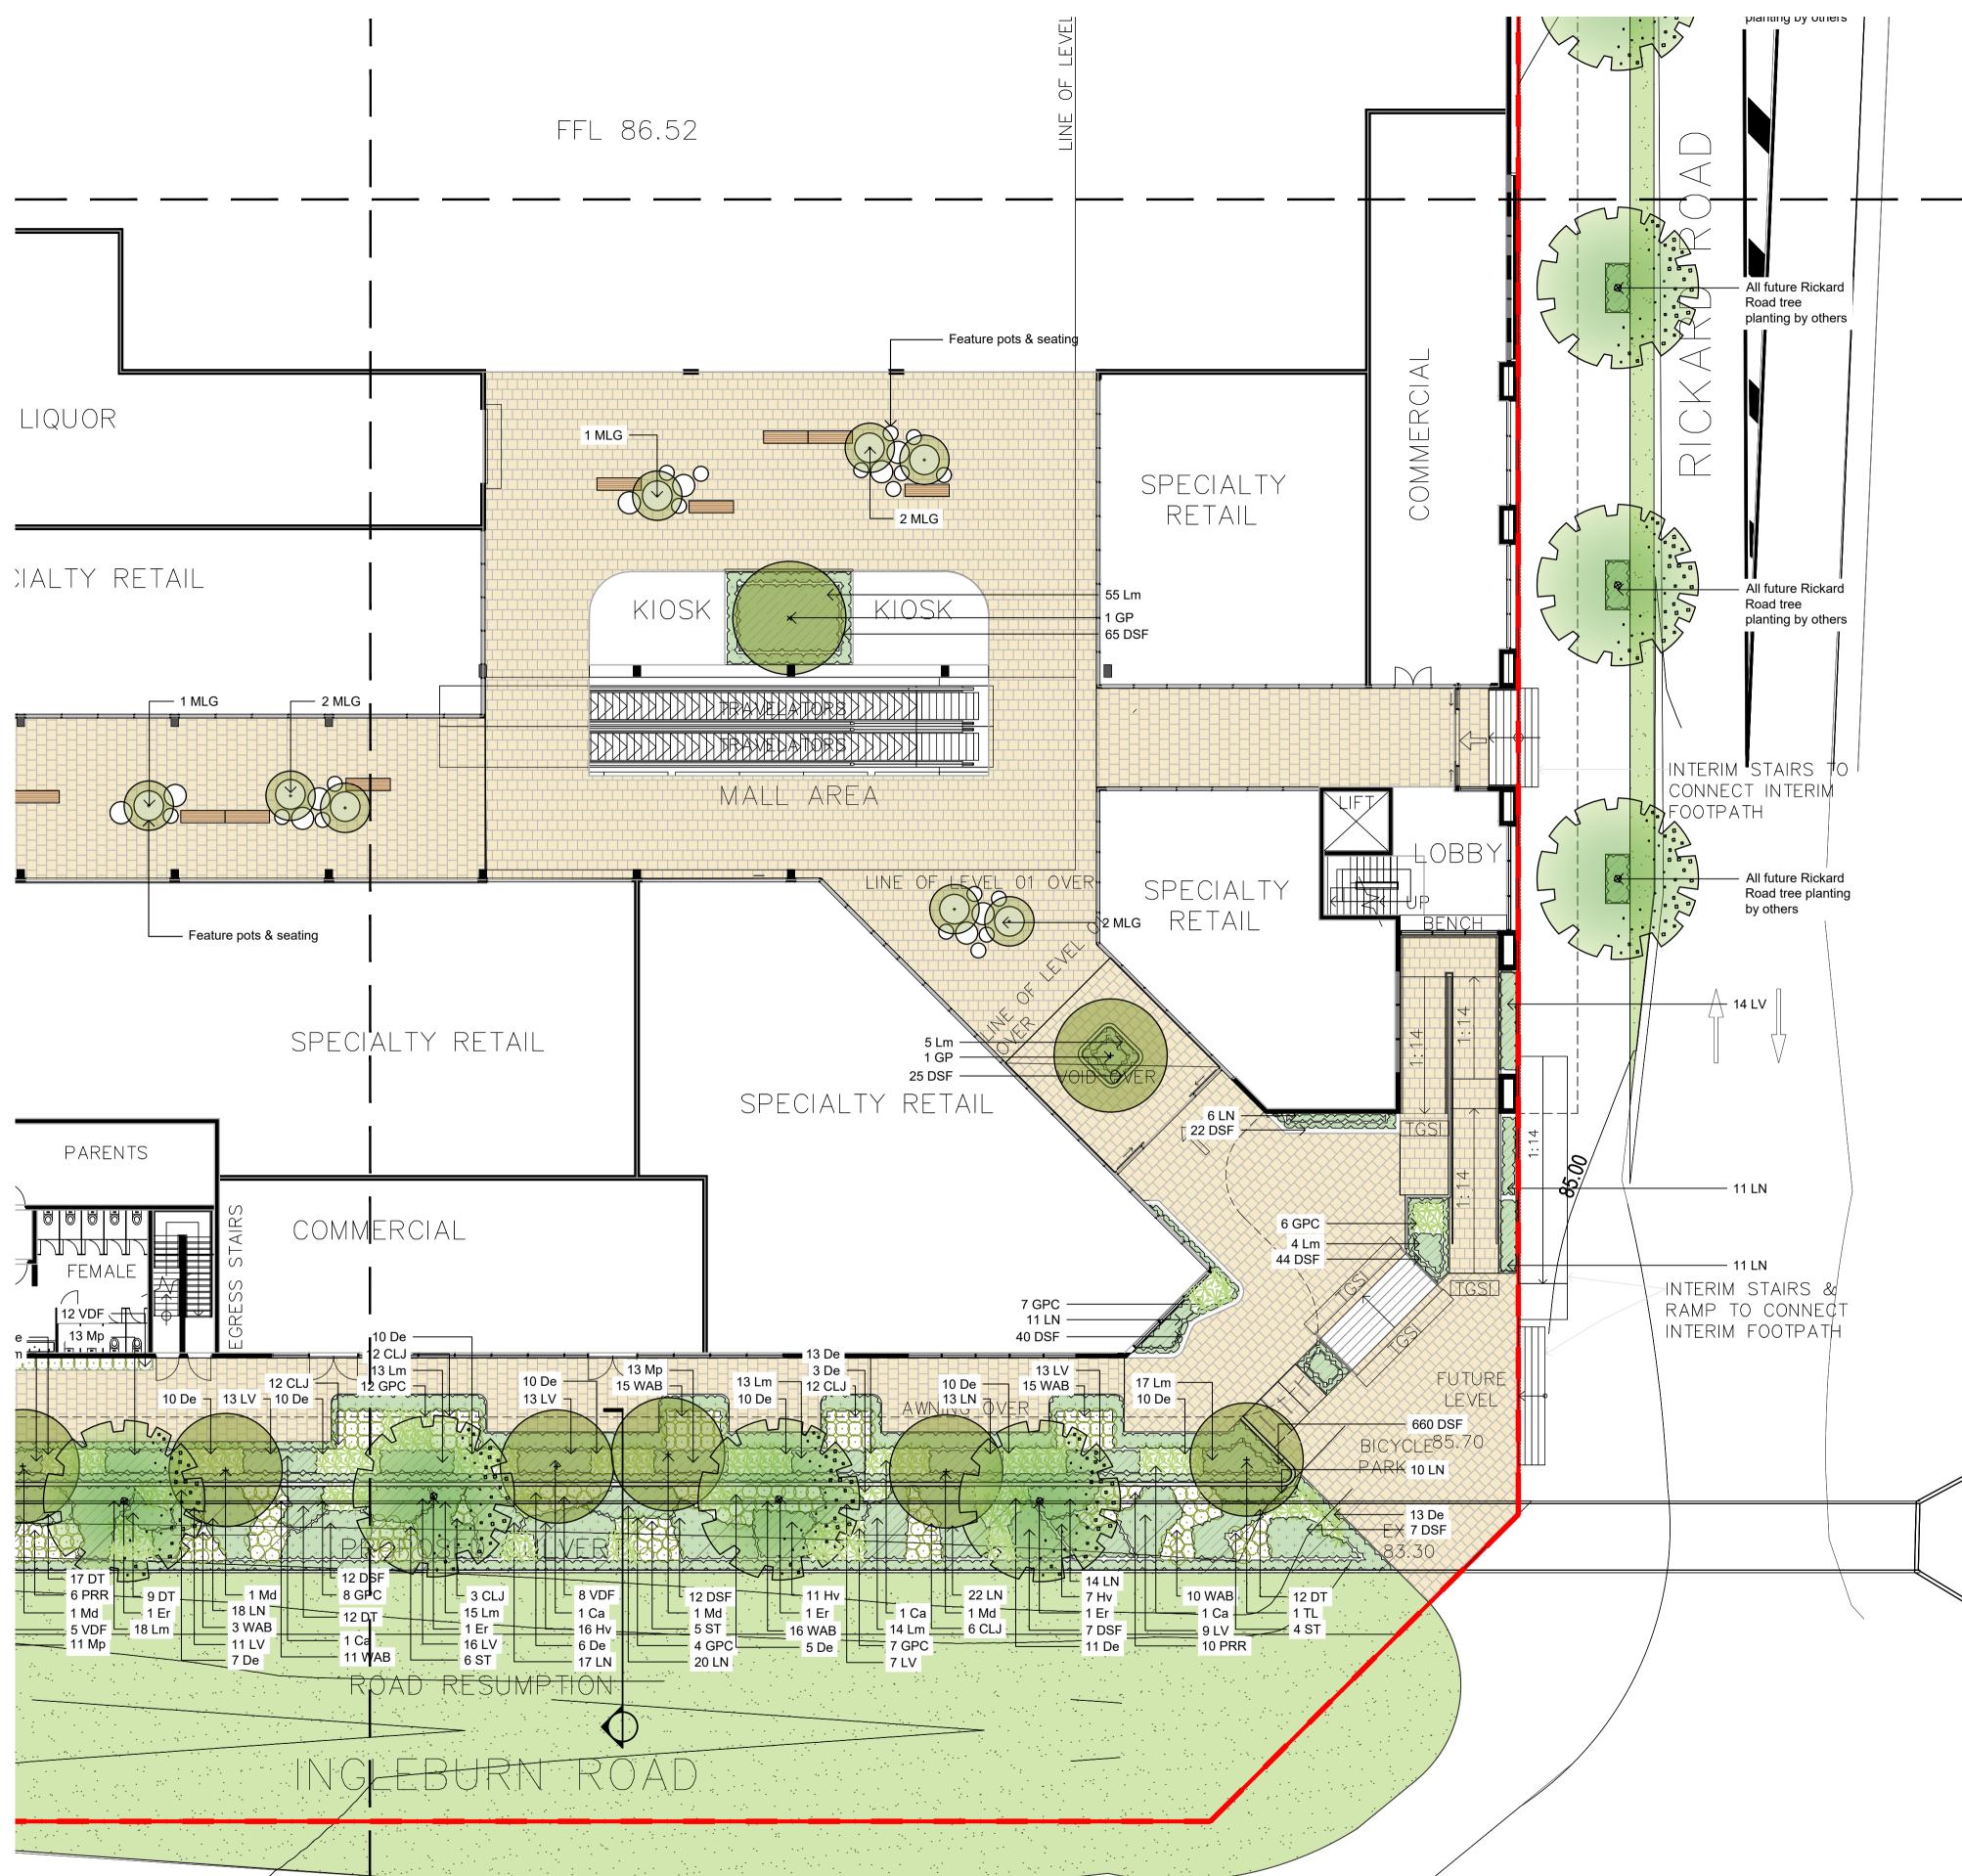

© 2016 Site Image (NSW) Pty Ltd ABN 44 801 262 380 as agent for Site Image NSW Partnership. All rights reserved. This drawing is copyright and shall not be reproduced or copied in any form or by any means (graphic, electronic or mechanical including photocopy) without the written permission of Site Image (NSW) Pty Ltd Any license, expressed or implied, to use this document for any purpose what so ever is restricted to the terms of the written agreement between Site Image (NSW) Pty Ltd and the instructing party.

JOINS 102

The contractor shall check and verify all work on site (including work by others) before commencing the landscape installation. Any discrepancies are to be reported to the Project Manager or Landscape Architect prior to commencing work. Do not scale this drawing. Any required dimensions not shown shall be referred to the Landscape Architect for confirmation.

F	Architectural Coordination	JM	NM	02.02.2021
E	Architectural Coordination	JM	NM	13.11.2020
D	Architectural Coordination	JM	NM	24.09.2020
С	Updated Civil Drawings	SM	NM	30.03.2020
В	Architectural Coordination	JM	NM	25.03.2020
А	For Review	JM	NM	17.02.2020
Issue	Revision Description	Drawn	Check	Date

LEGEND

Property Boundary

Basement Line

Existing Tree Retained

Proposed Tree

 γ , γ , Proposed Shrubs/ Accents

Proposed Groundcover/ Grasses

Turf

Unit Paving 400x400 Stretcher Semi Honed Colour: TBC

Client: Fabcot Pty Ltd



Project: Woolworths Leppington 116 Ingleburn Road, Leppington

Level 1, 3-5 Baptist Street Redfern NSW 2016 Australia

SITE IMAGE

Tel: (61 2) 8332 5600 Fax: (61 2) 9698 2877 www.siteimage.com.au


Site Image (NSW) Pty Ltd ABN 44 801 262 380




DEVELOPMENT APPLICATION

Drawing Name: Landscape Plan

Scale: 1:150 @ A1 Job Number:

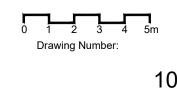

SS20-4303

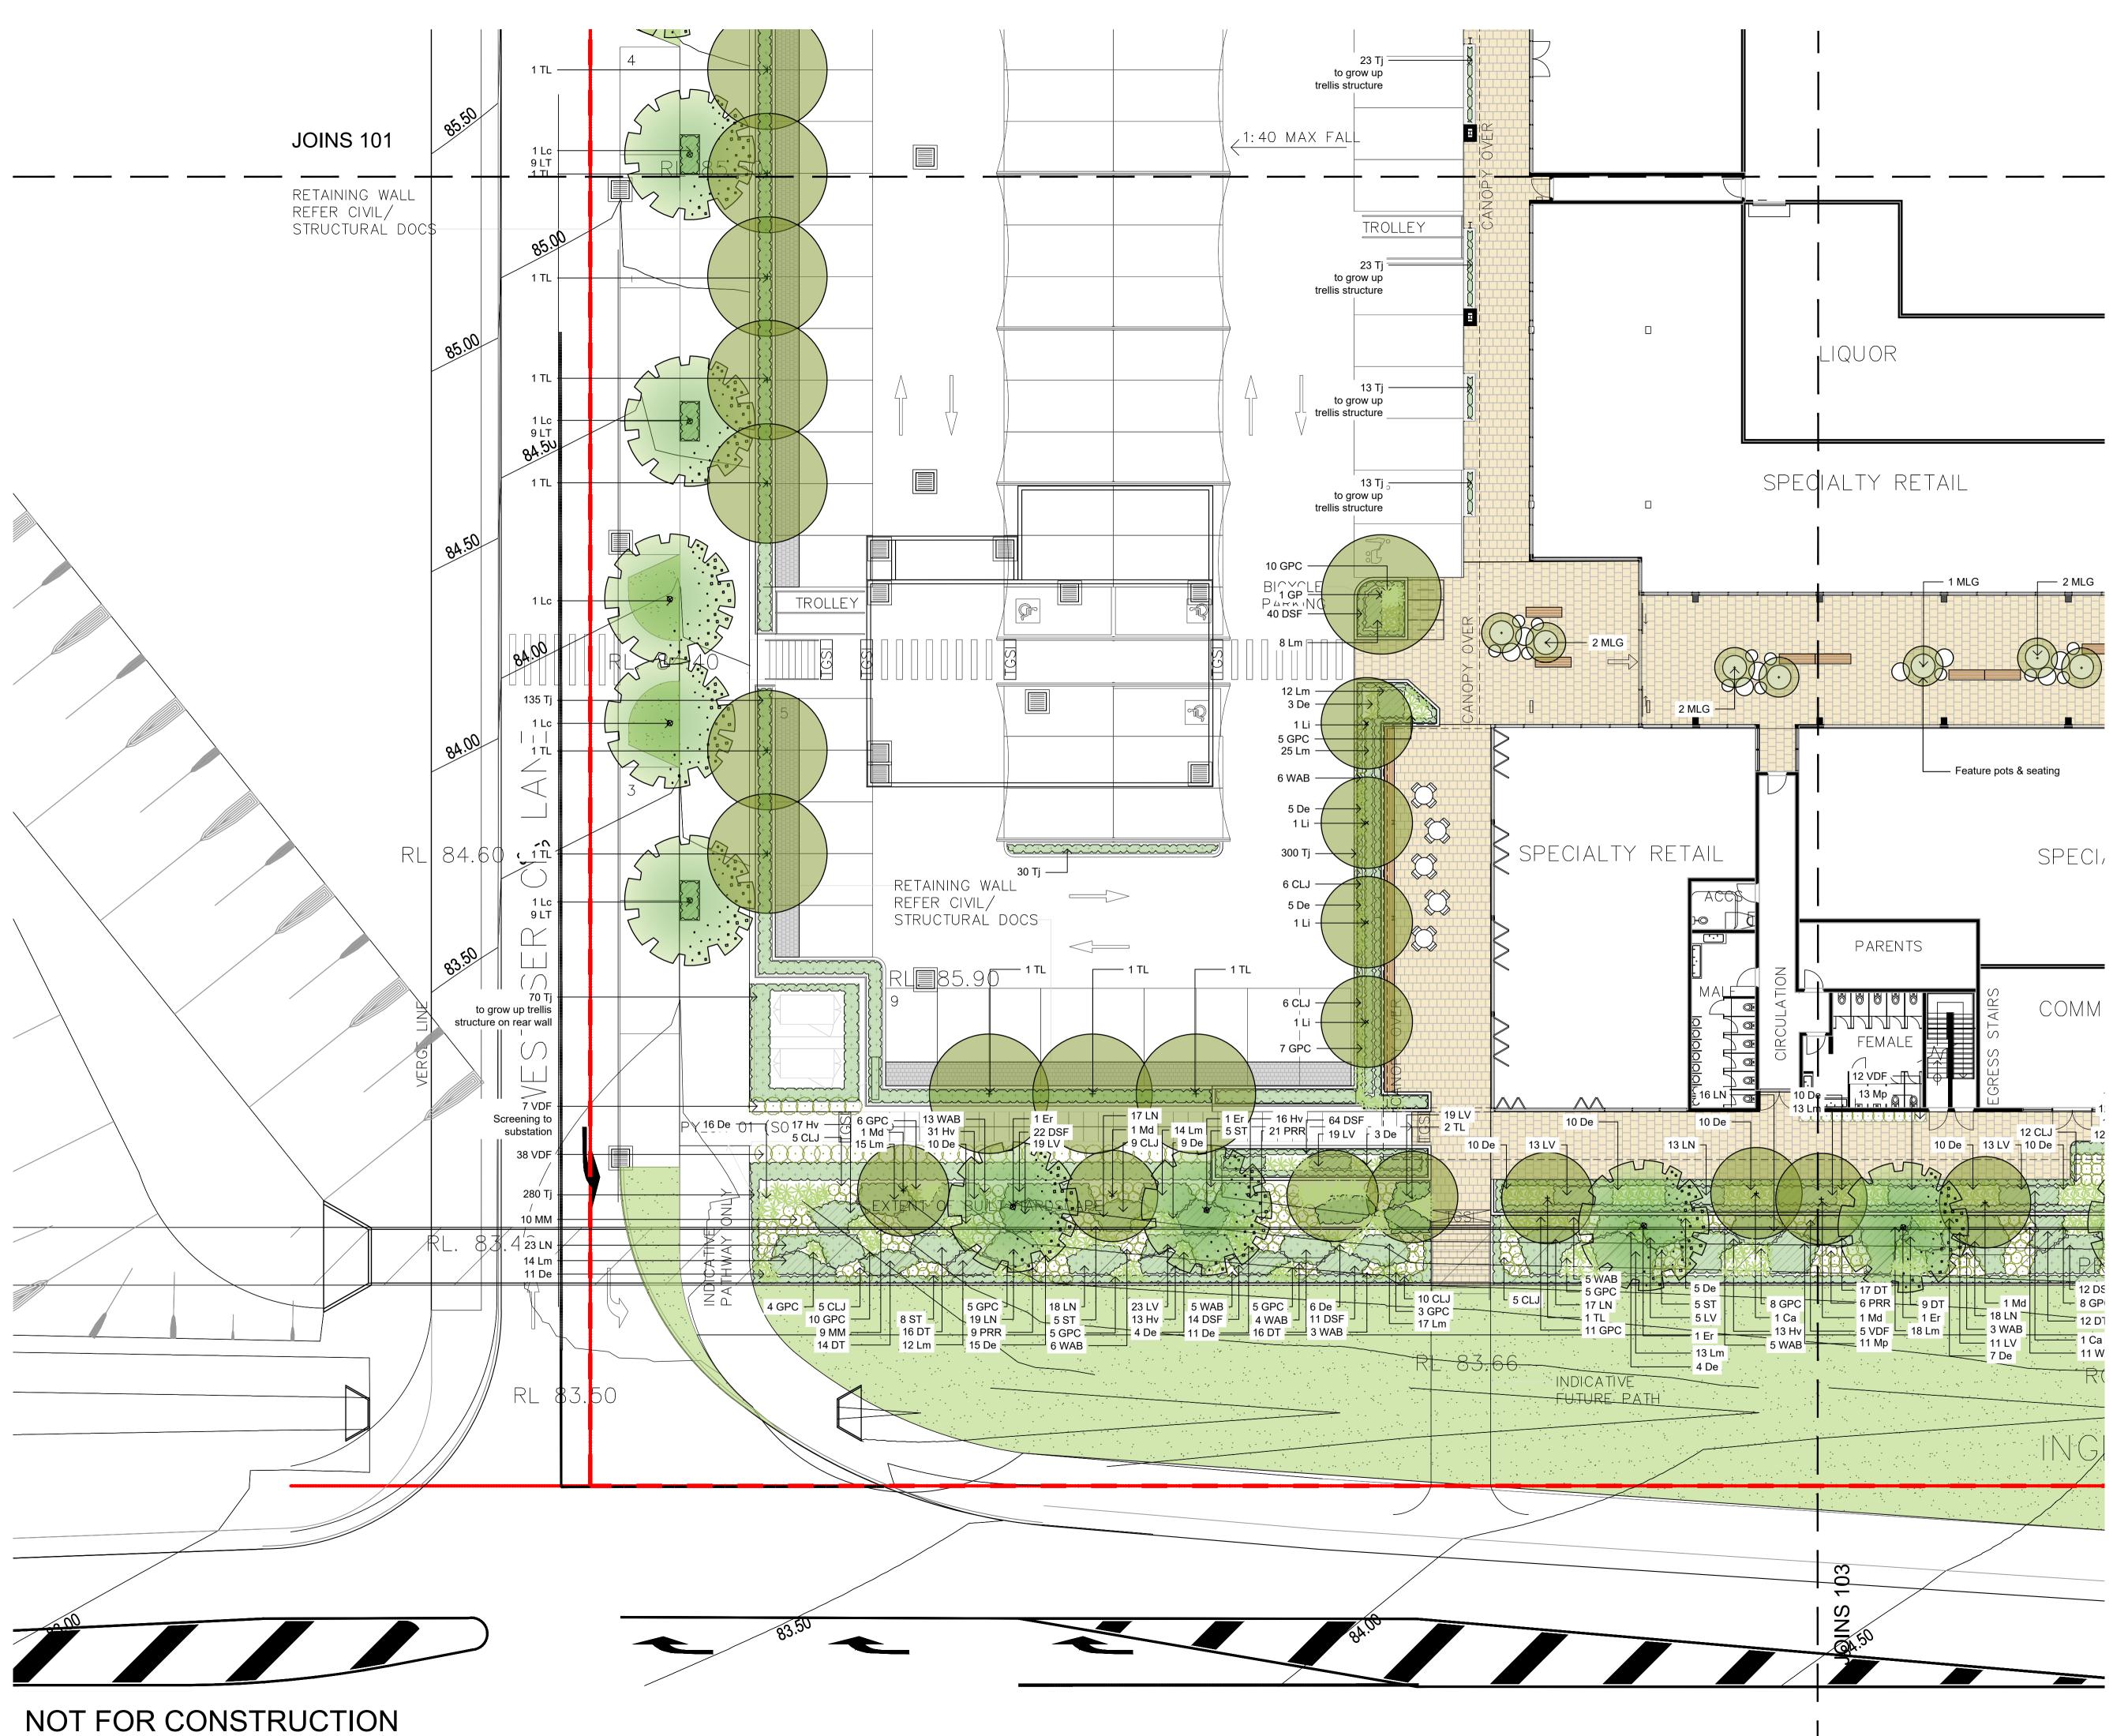

© 2016 Site Image (NSW) Pty Ltd ABN 44 801 262 380 as agent for Site Image NSW Partnership. All rights reserved. This drawing is copyright and shall not be reproduced or copied in any form or by any means (graphic, electronic or mechanical including photocopy) without the written permission of Site Image (NSW) Pty Ltd Any license, expressed or implied, to use this document for any purpose what so ever is restricted to the terms of the written agreement between Site Image (NSW) Pty Ltd and the instructing party.

The contractor shall check and verify all work on site (including work by others) before commencing the landscape installation. Any discrepancies are to be reported to the Project Manager or Landscape Architect prior to commencing work. Do not scale this drawing. Any required dimensions not shown shall be referred to the Landscape Architect for confirmation.

JM NM 02.02.2021

JM NM 13.11.2020

SM NM 30.03.2020

JM NM 25.03.2020

JM NM 17.02.2020

JM

NM 24.09.2020

Issue Revision D	escription	Drawn	Check	Date
LEGEND				
	Property Bounda	ry		
	Basement Line			
	Existing Tree Re	tainec	ł	
·	Proposed Tree			
	Proposed Shrubs	s/ Acc	ents	
	Proposed Ground Grasses	dcove	er/	

Architectural Coordination

Architectural Coordination

Architectural Coordination

Updated Civil Drawings

For Review

Α

Architectural Coordination



Grasses Turf

Unit Paving 400x400 Stretcher Semi Honed Colour: TBC

Fabcot Pty Ltd

Proiect Woolworths Leppington 116 Ingleburn Road, Leppington

Level 1, 3-5 Baptist Street Redfern NSW 2016

Australia Tel: (61 2) 8332 5600 Fax: (61 2) 9698 2877 www.siteimage.com.au Site Image (NSW) Pty Ltd ABN 44 801 262 380




SITE IMAGE

Landscape Architects


DEVELOPMENT APPLICATION

Drawing Name: Landscape Plan

Scale: 1:150 @ A1 Job Number:

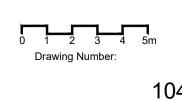

SS20-4303

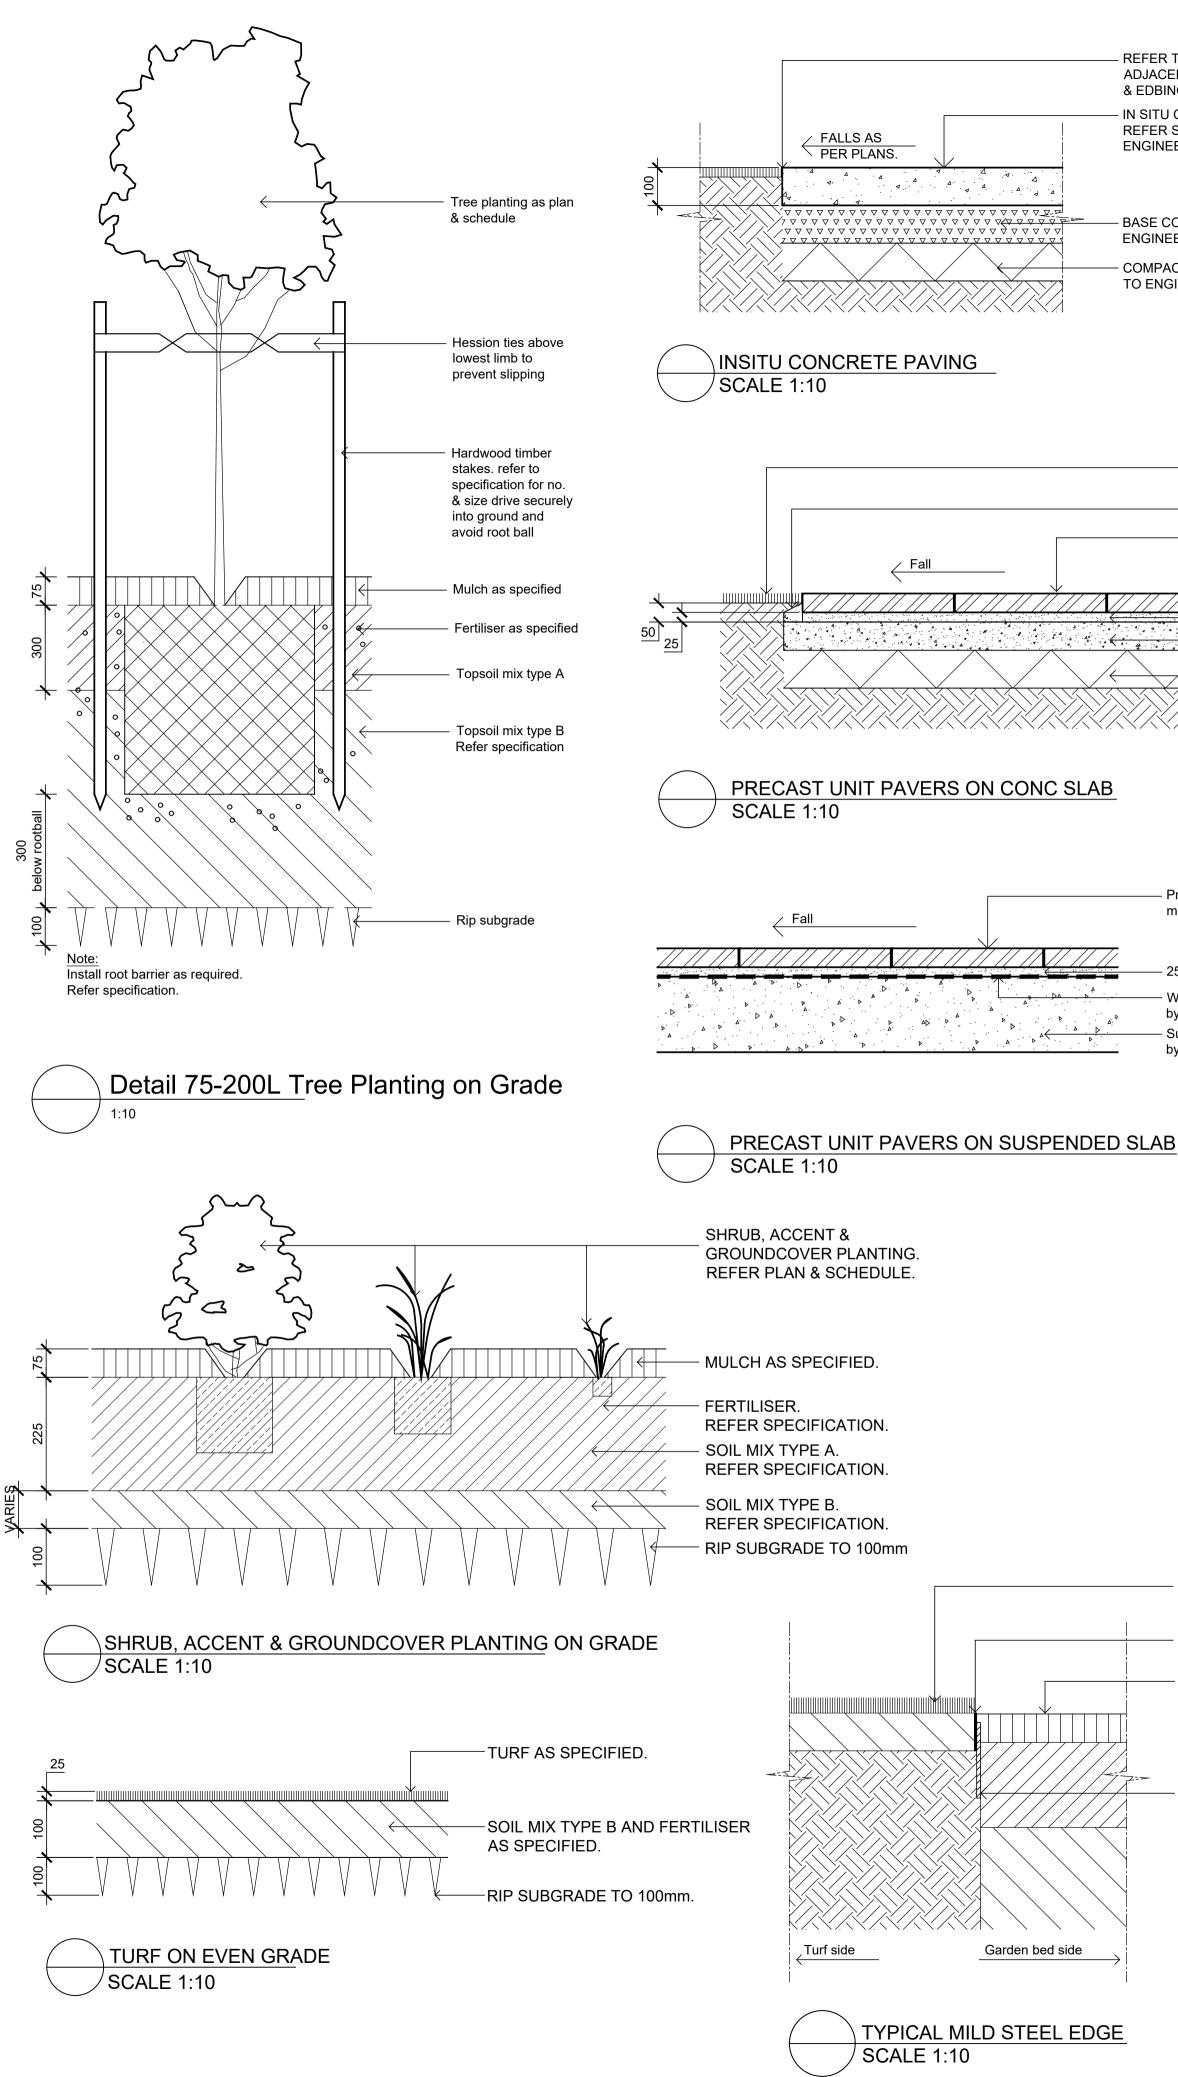

REFER TO PLANS FOR ADJACENT SURFACES & EDBING. IN SITU CONCRETE PAVING.

REFER SPECIFICATION & ENGINEERS SPECIFICATION.

BASE COURSE AS PER ENGINEER'S SPECIFICATION.

COMPACTED SUBGRADE TO ENGINEERS SPECIFICATION.

> Refer to plans for adjacent surfaces and edging Concrete haunch at edge Precast paving with mortar

> > joints as specified


25mm mortar bed Concrete base slab as per 4 Engineer's specification - Compacted sub-grade to Engineer's specification


25mm mortar bed. Waterproofing & drainage by others. Suspended concrete slab by others.	 Precast unit paving with mortar joints as specified.
	Waterproofing & drainage by others. Suspended concrete slab


Turf as specified Mild steel edge Refer specification Mulch as specified Nom. 10mm x 10mm x



200mm steel peg Spot weld to edge at 1.0m centres or at central junctions

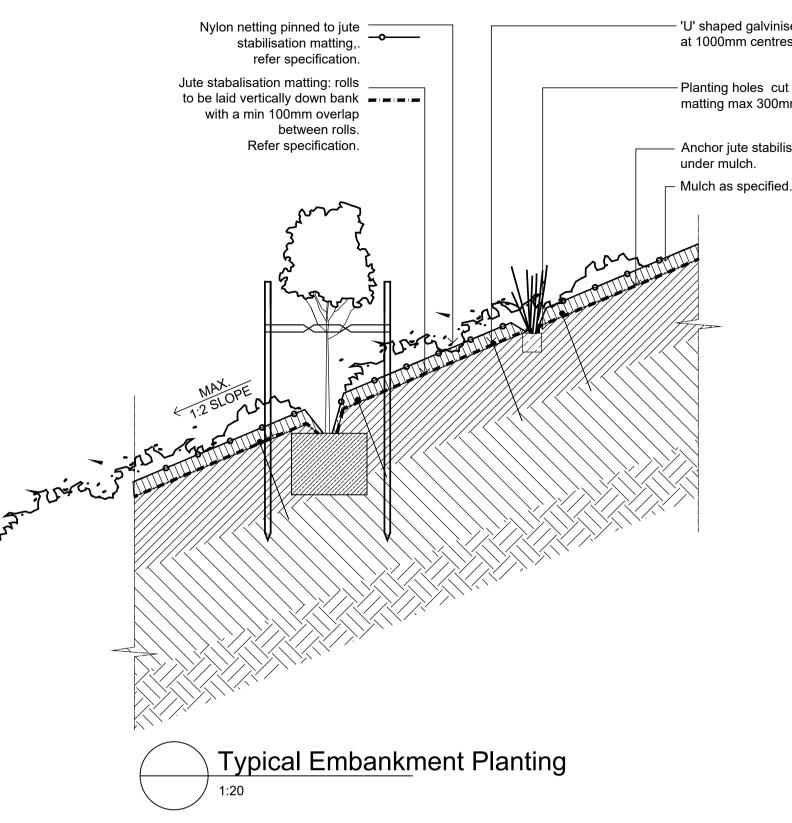

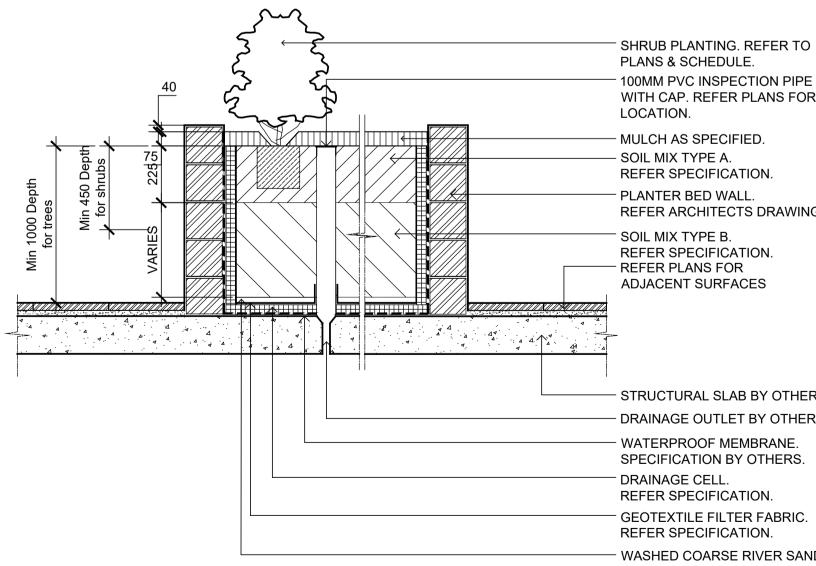

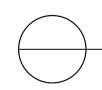

TYP. RAISED PLANTER BED ON SUSPENDED SLAB - SECTION SCALE 1:20

© 2016 Site Image (NSW) Pty Ltd ABN 44 801 262 380 as agent for Site Image NSW Partnership. All rights reserved. This drawing is copyright and shall not be reproduced or copied in any form or by any means (graphic, electronic or mechanical including photocopy) without the written permission of Site Image (NSW) Pty Ltd Any license, expressed or implied, to use this document for any purpose what so ever is restricted to the terms of the written agreement between Site Image (NSW) Pty Ltd and the instructing party.

The contractor shall check and verify all work on site (including work by others) before commencing the landscape installation. Any discrepancies are to be reported to the Project Manager or Landscape Architect prior to commencing work. Do not scale this drawing. Any required dimensions not shown shall be referred to the Landscape Architect for confirmation.

- 'U' shaped galvinised steel pegs secured at 1000mm centres (min. 450mmlong)

Planting holes cut into jute stabalisation matting max 300mm x 300mm

- Anchor jute stabilisation matting

F	Architectural Coordination	JM	NM	02.02.2021
Е	Architectural Coordination	JM	NM	13.11.2020
D	Architectural Coordination	JM	NM	24.09.2020
С	Updated Civil Drawings	SM	NM	30.03.2020
В	Architectural Coordination	JM	NM	25.03.2020
А	For Review	JM	NM	17.02.2020
Issue	Revision Description	Drawn	Check	Date

LEGEND

PLANS & SCHEDULE. - 100MM PVC INSPECTION PIPE WITH CAP. REFER PLANS FOR MULCH AS SPECIFIED. SOIL MIX TYPE A. REFER SPECIFICATION. PLANTER BED WALL REFER ARCHITECTS DRAWINGS. SOIL MIX TYPE B. REFER SPECIFICATION. REFER PLANS FOR ADJACENT SURFACES

STRUCTURAL SLAB BY OTHERS DRAINAGE OUTLET BY OTHERS WATERPROOF MEMBRANE. SPECIFICATION BY OTHERS. DRAINAGE CELL. REFER SPECIFICATION. GEOTEXTILE FILTER FABRIC. REFER SPECIFICATION. WASHED COARSE RIVER SAND.

Client: Fabcot Pty Ltd

Project: Woolworths Leppington 116 Ingleburn Road, Leppington

Level 1, 3-5 Baptist Street Redfern NSW 2016

Australia

SITE IMAGE

Tel: (61 2) 8332 5600 Fax: (61 2) 9698 2877 www.siteimage.com.au Site Image (NSW) Pty Ltd ABN 44 801 262 380



DEVELOPMENT APPLICATION


Drawing Number:

Drawing Name: Landscape Details

Scale: As Shown Job Number:

SS20-4303

Issue

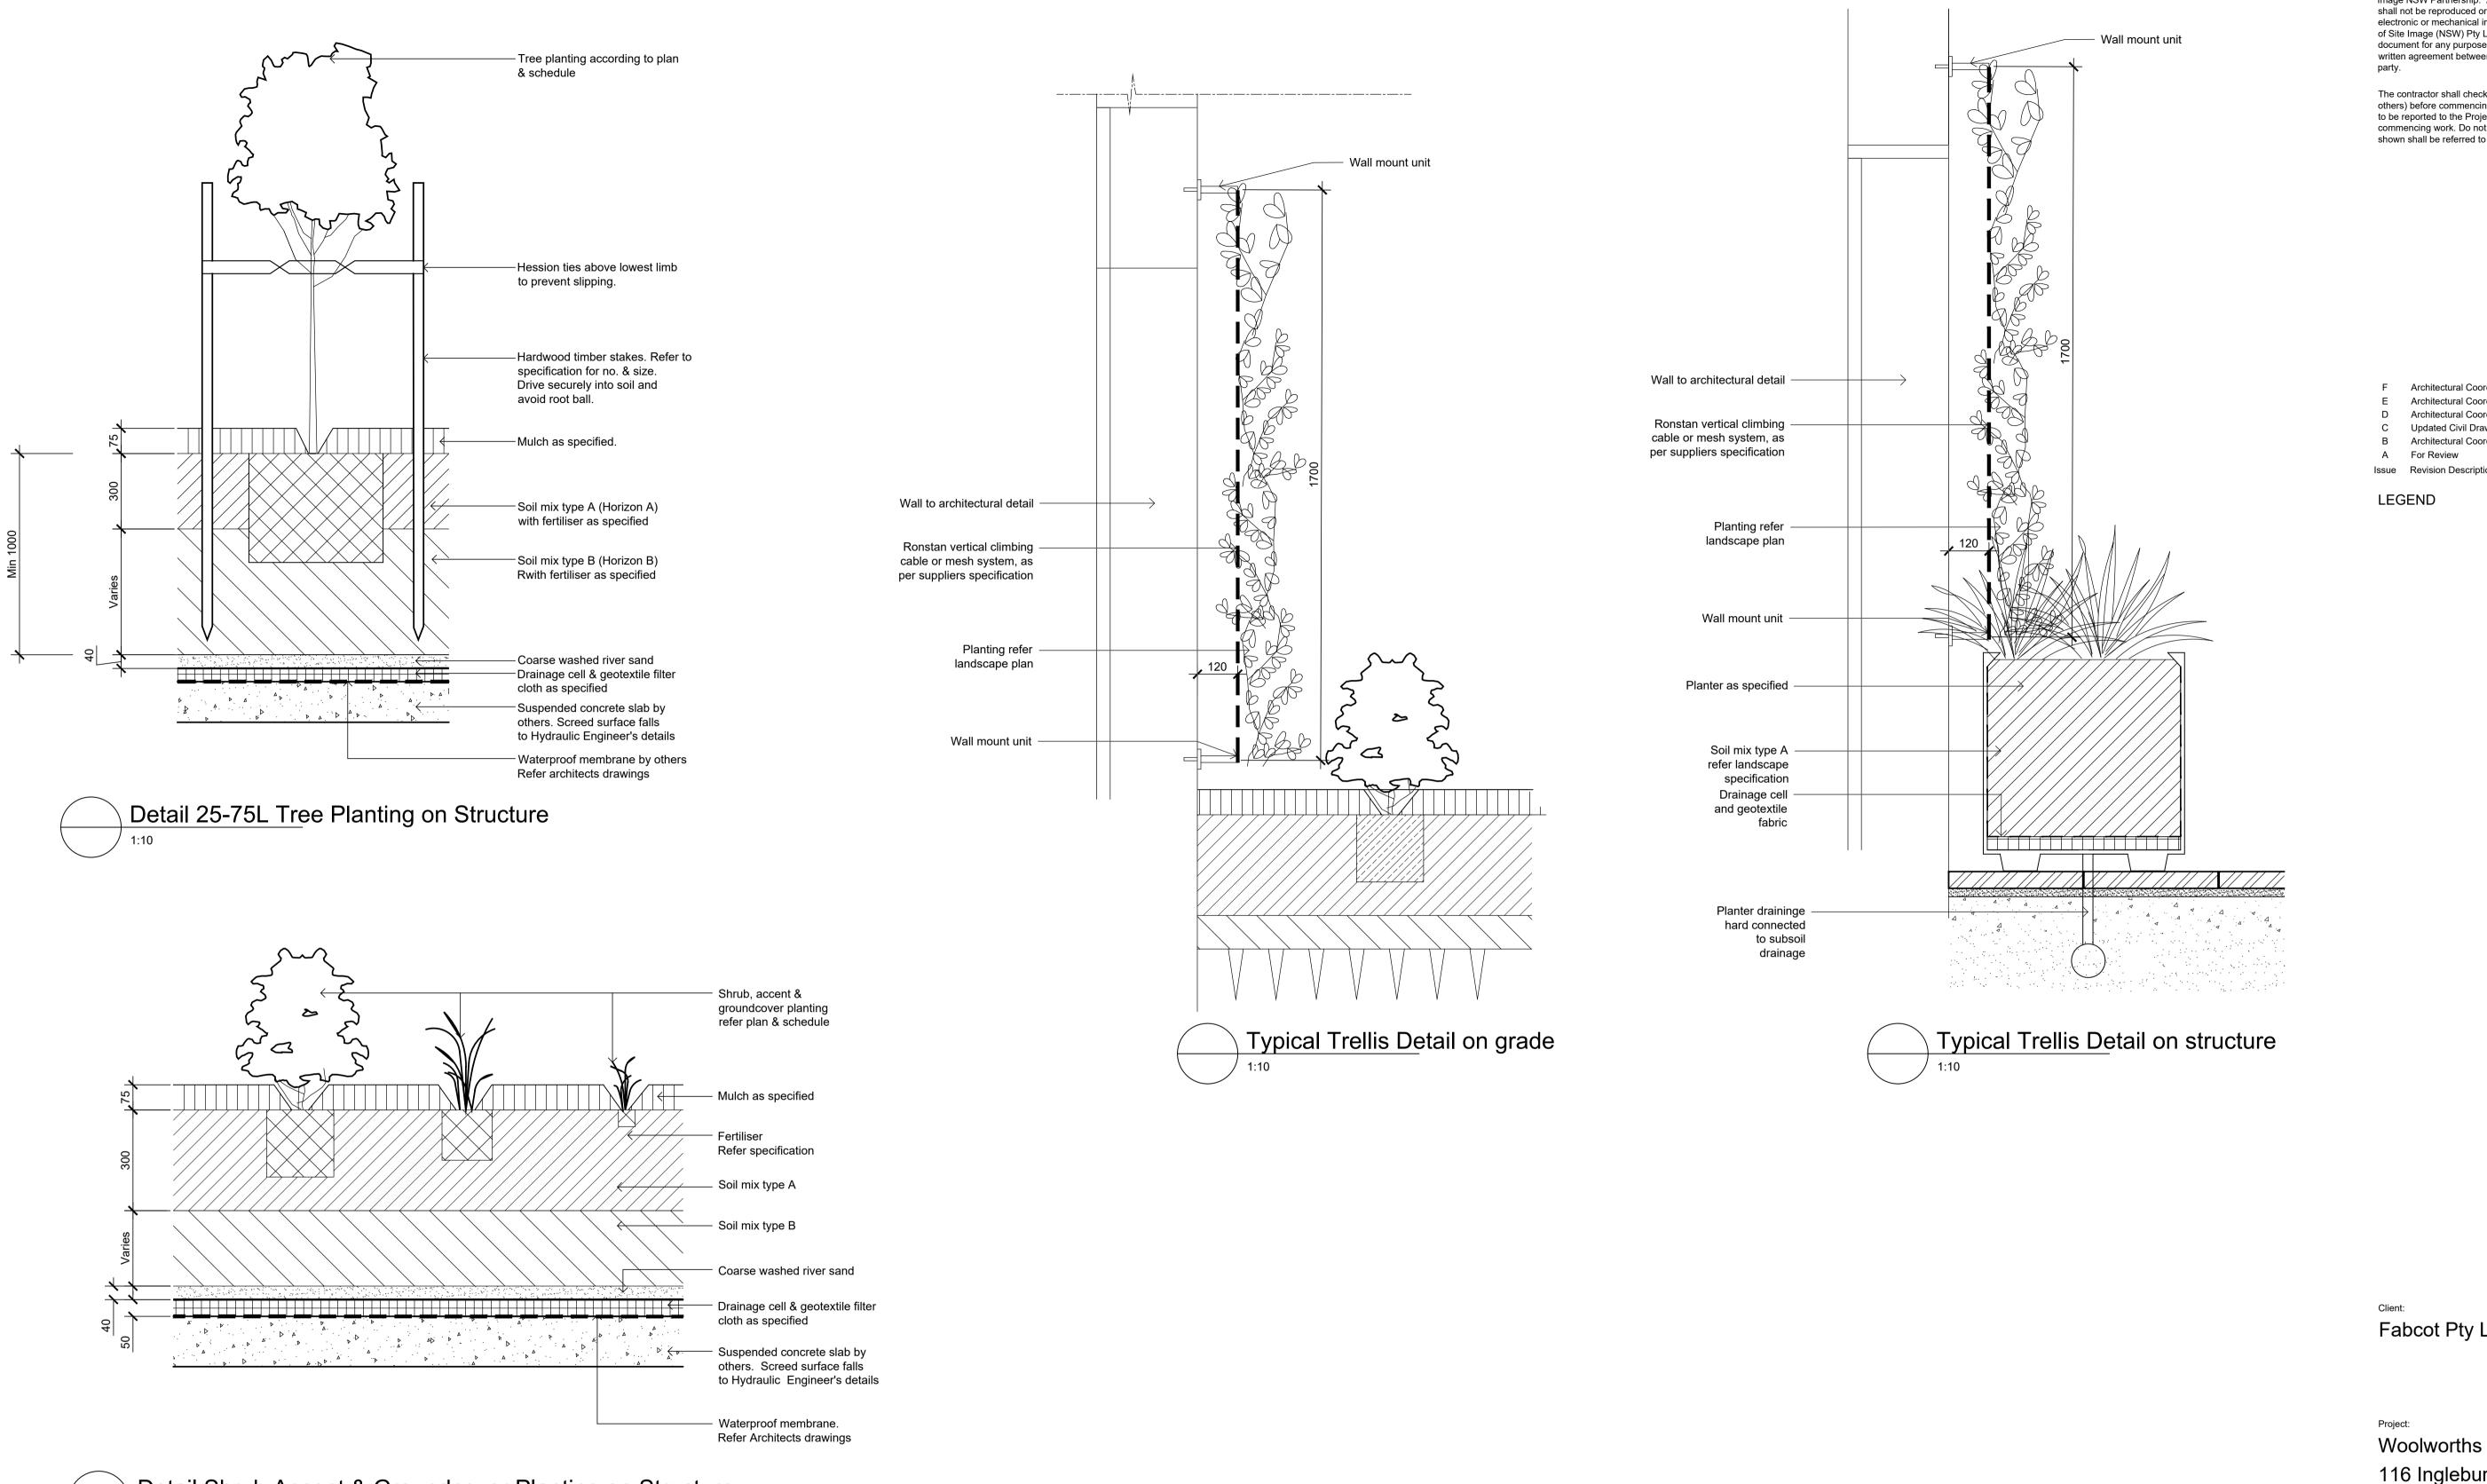


Detail Shrub Accent & Groundcover Planting on Structure 1:10

© 2016 Site Image (NSW) Pty Ltd ABN 44 801 262 380 as agent for Site Image NSW Partnership. All rights reserved. This drawing is copyright and shall not be reproduced or copied in any form or by any means (graphic, electronic or mechanical including photocopy) without the written permission of Site Image (NSW) Pty Ltd Any license, expressed or implied, to use this document for any purpose what so ever is restricted to the terms of the written agreement between Site Image (NSW) Pty Ltd and the instructing

The contractor shall check and verify all work on site (including work by others) before commencing the landscape installation. Any discrepancies are to be reported to the Project Manager or Landscape Architect prior to commencing work. Do not scale this drawing. Any required dimensions not shown shall be referred to the Landscape Architect for confirmation.

F E D C B	Architectural Coordination Architectural Coordination Architectural Coordination Updated Civil Drawings Architectural Coordination	JM JM JM SM JM	NM NM NM NM	02.02.2021 13.11.2020 24.09.2020 30.03.2020 25.03.2020
А	For Review	JM	NM	17.02.2020
Issue	Revision Description	Drawn	Check	Date

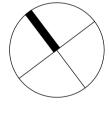

Fabcot Pty Ltd

Woolworths Leppington 116 Ingleburn Road, Leppington

Level 1, 3-5 Baptist Street Redfern NSW 2016 Australia



Tel: (61 2) 8332 5600 Fax: (61 2) 9698 2877 www.siteimage.com.au Site Image (NSW) Pty Ltd ABN 44 801 262 380




DEVELOPMENT APPLICATION


Drawing Name: Landscape Details


Scale: As Shown Job Number:

SS20-4303

Issue:

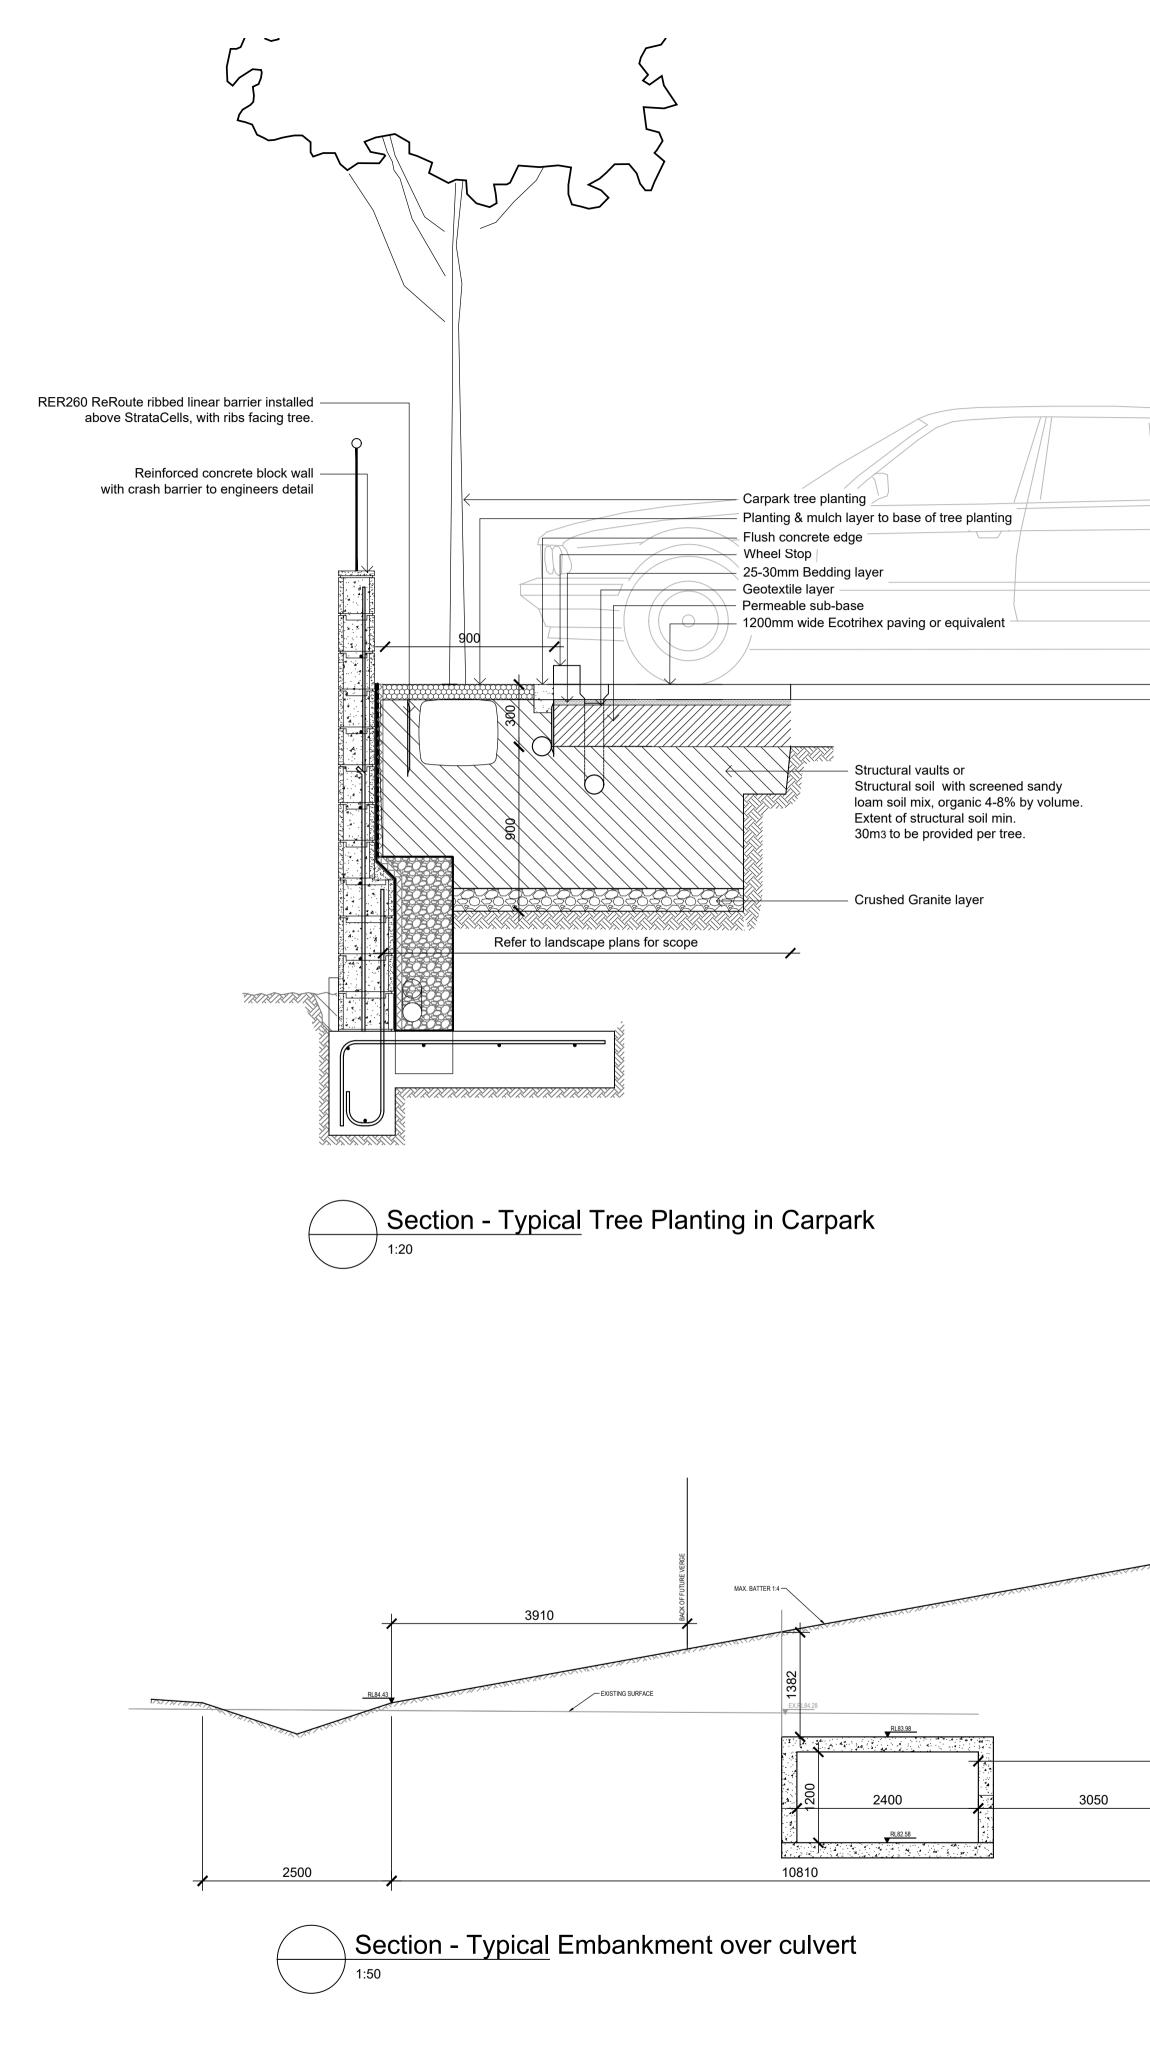

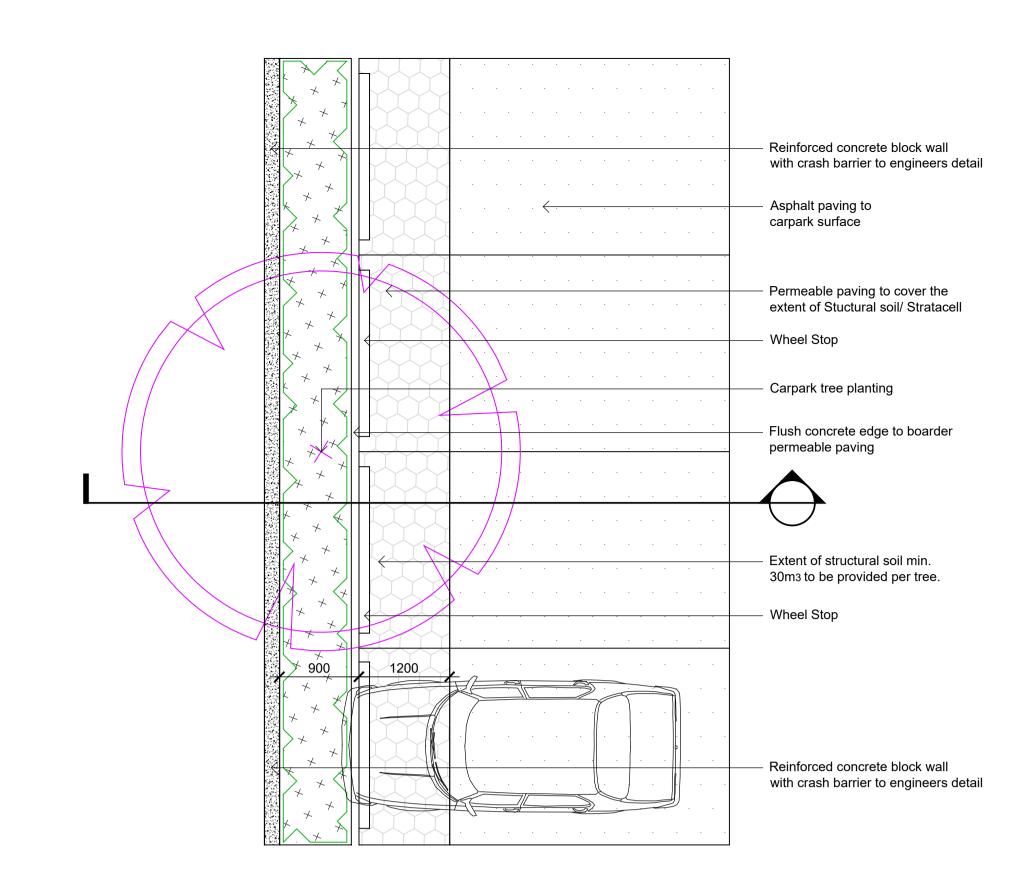

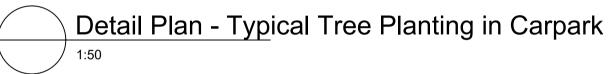

Structural Support Soil

Structural support soil is intended for use in relation to tree planting in road verges, median strips, paved plazas and the like. This soil system is comprised of two components, a stone lattice for strength and structural support (load bearing) filler soil to service the horticultural needs of the plants. The system shall be engineered to maintain a high degree of porosity after installation and compaction and should have the characteristics listed in Table B2 below.

Table B2 – Structural Support Soil (SSS)		
Nominal 63mm hard rock aggregate (usually basalt, diorite or granite)		
Filler soil (preferably loam to clay loam		
S sieve mm	% passing sieve	
3.0	100	
3	85 - 100	
7.5	20 - 65	
5.5	0 - 20	
9.0	0 - 5	
3.2	0 – 2	
75	0 - 1	
odium sulphate soundness (total weight %	Max. 9	
ggregate to filler soil ratio*	4.5 – 5.5	
	ate (usually basalt, diorite or granite) ay loam 5 sieve mm 5.0 5.5 5.5 5.5 5.5 5.5 5.5 5.5 5.5 5.5	

* The aggregate to filler soil ratio test method will be:
1. Pack mixed SSS into a calibrate 10 or 20 L bucket compacting well.

2. Pass the entire SSS sample from the bucket over a 4.75 mm sieve.


3. Measure the volume of fine material by pouring into a 2 L plastic measuring cylinder and dumping to firm down by dropping from 5 cm 10 times. 4. Calculate the aggregate to filler soil ratio by dividing the total volume by the measured volume of filler soil.

	Fertilisers
Filler soil clay loam, sandy clay or clay	80 – 90% v/v
Composted soil conditioner conforming to AS 4454	10 – 20% v/v
Gypsum	500 g/m³ of filler soil
Urea	500 g/m³ of filler soil
Iron sulphate	1.5 kg/m ³ of filler soil
Magnesium sulphate	400 g/m ³ of filler soil
Lime or dolomite	600 g/m ³ of filler soil
Potassium nitrate	500 g/m³ of filler soil
Superphosphate	500 g/m³ of filler soil
Trace element mix	300 g/m ³ of filler soil
8 – 9 month controlled release	2 kg/m ³ of filler soil

The ratio of filler soil to aggregate is critical in achieving the engineering and horticultural objective. The 'aggregate', 'filler soil' and blending ratio of the two shall be as specified and carefully validated. Generally, the ratio of aggregate to filler soil shall be an amount of filler soil equal to half the void space of the compacted aggregate. If the aggregate has a void space of 40% the ratio will be 10 parts aggregate by volume to 2 parts filler soil.

It should be noted that the total volume of SSS is determined by the volume of aggregate only because adding filler soil does not increase the overall volume. The filler soil takes up void space only but must be calculated as cost factor of SSS.

SSS must be a uniformly blended mixture of aggregate and filler soil and are prone to being segregated during handling at the source and during transport. Particular care must be taken to ensure that all structural soil is thoroughly mixed before placement and compaction. To assist this, and to prevent segregation, ensure that the mixture remains moist at all times during mixing, transport, storage and placement.

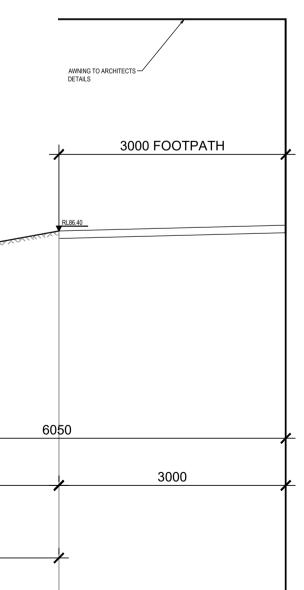

© 2016 Site Image (NSW) Pty Ltd ABN 44 801 262 380 as agent for Site Image NSW Partnership. All rights reserved. This drawing is copyright and shall not be reproduced or copied in any form or by any means (graphic, electronic or mechanical including photocopy) without the written permission of Site Image (NSW) Pty Ltd Any license, expressed or implied, to use this document for any purpose what so ever is restricted to the terms of the written agreement between Site Image (NSW) Pty Ltd and the instructing party.

The contractor shall check and verify all work on site (including work by others) before commencing the landscape installation. Any discrepancies are to be reported to the Project Manager or Landscape Architect prior to commencing work. Do not scale this drawing. Any required dimensions not shown shall be referred to the Landscape Architect for confirmation.

F	Architectural Coordination	JM	NM	02.02.2021
Е	Architectural Coordination	JM	NM	13.11.2020
D	Architectural Coordination	JM	NM	24.09.2020
С	Updated Civil Drawings	SM	NM	30.03.2020
В	Architectural Coordination	JM	NM	25.03.2020
А	For Review	JM	NM	17.02.2020
Issue	Revision Description	Drawn	Check	Date

LEGEND







Client: Fabcot Pty Ltd

Project: Woolworths Leppington 116 Ingleburn Road, Leppington

Level 1, 3-5 Baptist Street Redfern NSW 2016 Australia

SITE IMAGE

Tel: (61 2) 8332 5600 Fax: (61 2) 9698 2877 www.siteimage.com.au Site Image (NSW) Pty Ltd ABN 44 801 262 380



DEVELOPMENT APPLICATION

Drawing Name: Landscape Details

Scale: As Shown Job Number:

SS20-4303

PLANT SCHDEULE

Symbol	Botanical Name	Common Name	Mature size H x W (m)	Pot Size	Density	Quantity
Trees						
Ca	Cupaniopsis anarcardiodes	Tuckeroo	7 x 3	100L	As Shown	5
Er	Elaeocarpus reticulatus	Blueberry Ash	9 x 6	100L	As Shown	7
GP	Ginko biloba 'Princeton Sentry'	Tall Narrow Ginko	10 x 3	200L	As Shown	3
Lc	Lophostemon confertus	Brush Box	8 x 6	200L	As Shown	21
Li	Lagerstroemia indica 'Natchez'	Crepe Myrtle	8 x 6	100L	As Shown	4
Md	Melaleuca decora	White Cloud Tree	6 x 4	100L	As Shown	6
MLG	Magnolia grandiflora 'Little Gem'	Dwarf Magnolia	4 x 2	100L	As Shown	12
TL	Tristaniopsis 'Lucious'	Water Gum	9 x 4	100L	As Shown	27
Shrubs &	Accents					
CLJ	Callistemon 'Little John'	Bottlebrush	1 x 1	300mm	As Shown	
GP	Grevillea 'Peaches & Cream'	Peaches & Cream Grevillea	1.5 x 2	300mm	As Shown	
MM	Murraya 'Min a Min'	Dwarf Murraya	1 x 1	300mm	As Shown	
PRR	Photonia 'Red Robin'	Red Robin	2 x 1.5	300mm	As Shown	
ST	Syzygium 'Tiny Tre'	Tiny Trev	0.5 x 1	300mm	As Shown	
VDF	Viburnum 'Dense Fence'	Dense Fence	2 x 2	300mm	As Shown	
WAB	Westringia 'Aussie Box'	Coastal Rosemary	1.2 x 1.2	300mm	As Shown	
Grasses	& Groundcovers					
DSF	Dichondra 'Silver Falls'	Silver Falls	0.2 x 0.5	150mm	5/m²	
DT	Dianella caerulea 'Tasred'	Flax Lily	0.5 x 0.5	150mm	5/m²	
Hv	Hardenbergia violacea	Purple Coral Pea	Spreading	150mm	5/m²	
Lm	Liriope muscari 'Just Right'	Lily	0.5 x 0.5	150mm	5/m²	
LN	Lomandra 'Nyalla'	Nyalla Lomandra	1 x 1	150mm	5/m²	
LV	Lomandra longifolia 'Verday'	Mat Rush	0.7 x 0.7	150mm	5/m²	
Мр	Myoporum parvifolium	Creeping boobialla	0.3 x 1.5	150mm	5/m²	
Tj	Trachelospermum jasminoides	Star Jasmine	0.3 x 1.5	150mm	5/m²	



NOT FOR CONSTRUCTION

SPECIFICATION GENERAL NOTES

References

All plans and details included in the project documents shall be read in **Plants** conjunction with this specification. All structural and civil works components of the landscape design shall be referenced to engineers' details and specifications. Read this specification in conjunction with the plant and materials schedule on this drawing. If in doubt about any or damage; detail or if conflicts are found in the documents, seek advice.

Workmanship and Materials

The whole of the landscape works shall be carried out by a competent, trained and qualified landscape contractor who is experienced in • Grown in final containers for not less than twelve weeks; The landscape contractor shall hold a current Building Contractors License and/or be a financial member of LNA Landscape Association NSW & ACT or equivalent organisations in other states.

EARTHWORKS

Excavation, Trimming and Filling

Except as otherwise note in the contract, bulk excavation is excluded from the landscape works. Trim and fill the excavated ground surfaces correctly orientated to north or for best presentation. Backfill the to achieve design levels to accommodate finish materials as detailed. Compact the finished surface as required for the finished ground treatment.

Sub-soil Drainage

Keep the excavated works drained and free of standing water. Allow to manufacturer's recommendations around the plants in the soil at the supply and install sub-soil drainage pipes as required for the new works to ensure that all gardens are well drained. Connect the sub-soil drainage pipes to the nearest downstream stormwater pits. Include pipe filter socks.

SOFTWORKS

Soil Testing

Undertake at least two (2) soil tests, in locations as advised by Project Manager, and provide results and recommendations for the improvement of plant growth and to adjust the soil to achieve appropriate planting medium (including pit levels) for successful plant growth.

Excavate all garden beds to bring the subsoil to at least 300mm below finished design levels. Shape the subsoil to fall to subsoil drains where **Stakes and Ties** applicable. Do not excavate within the drip line of trees to be retained. Excavate all turf areas to bring the subsoil to at least 100mm below finished design levels. Shape the subsoil to fall to subsoil drains where various plant pot sizes: applicable. Do not excavate within the drip line of trees to be retained. • Plants (>25 lt): 1 off 38 x 38 x 1200mm; Cultivate the subsoil to a further depth of 100mm. Remove stones • Semi-advanced plants (>75 lt): 2 off 50x50x 1800mm; exceeding 25mm, clods of earth exceeding 50mm, and weeds, rubbish • Advanced (>100 lt): 3 off 50 x 50 x 2400mm. or other deleterious material brought to the surface during cultivation. Do not disturb services or tree roots, if necessary cultivate these areas IRRIGATION by hand. During cultivation, thoroughly mix in materials required to be incorporated into the subsoil, as recommended in the soil testing results and to manufacturer's recommendations. Trim the surface to design levels after cultivation.

Topsoil

Import topsoil for the garden and turf areas, unless the topsoil can be provided from material recovered from the site, as recommended in the layout of the entire irrigation is to ensure that each individual plant soil testing results. Spread the topsoil on the prepared subsoil and grade evenly, compact lightly and uniformly in 150mm layers. Avoid differential subsidence and excess compaction and produce a finished topsoil surface which has the following characteristics:

- flush with adjoining hard surfaces such as paths and edge;
- Smooth and free from stones or lumps of soil; • Graded to drain freely, without ponding, to catchment points;
- Graded evenly to adjoining surfaces; and Ready for planting.

Compost

Fertilise

Provide proprietary fertilisers, delivered to the site in sealed bags

marked to show manufacturer or vendor, weight, fertiliser type, N:P:K • Pruning; ratio, recommended uses and application rates.

- Supply plants in accordance with the landscape drawings and schedules, which have the following characteristics:
- Large healthy root systems, with no evidence of root curl, restriction Irrigation and watering;
- Vigorous, well established, free from disease and pests, of good form consistent with the species or variety:
- Hardened off, not soft or forced, and suitable for planting in the natural climatic conditions prevailing at the site, and in particular shade conditions;
- Trees, unless required to be multi-stemmed, shall have a single
- leading shoot; and Containers shall be free from weeds and of appropriate size in relation to their container.

Plant Installation

Following excavation of the planting hole place and spread 15gms of wetting agent pre-mixed with one (1) litre of water. Place the plant planting holes with specified topsoil mixture. Lightly tamp and water to eliminate air pockets. Ensure the topsoil is not placed over the top of the rootball. Keep the plant stem at the same height above the ground plants as it was above the soil in the container. Apply fertiliser, as recommended in the soil testing results or in accordance with the time of planting.

Root Barrier

Supply and install root control barriers to all new tree plantings adjacent to walls, paths and all trunk service trenches, where their proximity poses a threat to the stability of the infrastructure. Install in accordance with manufacturer's recommendations.

Mulch

mulch in all garden beds to a depth of 75mm, after all specified plants are installed. Keep mulch clear of all plant stems and rake to an even surface flush with the surrounding surfaces evenly graded between design surface levels. Over fill to allow mulch to settle to the specified

Stakes shall be durable hardwood, straight, free of knots and twists, pointed at one end, in the following quantities and sizes for each of the \circ

All proposed landscape areas shall be irrigated.

The irrigation system shall be an automatic fixed drip system, with an shall be compatible to the type of plant material and rates of water required. Where appropriate adjustable and fully serviceable. The receives the required amount of water to maintain healthy and vigorous correct depth as specified. growth. The irrigation system shall be such that, component theft, vandalism, over-spray and wetting of paths shall be reduced to a minimum or completely eliminated by the use of drip, pop-up sprinklers maintain healthy and vigorous growth, adjust and rectify as required. • Finished to design levels, allowing for mulch or turf, which is to finish and judiciously placed fixed spray emitters. Do not use fine mist type emitters that provide a drifting mist that may wet paths and the buildings.

LANDSCAPE MAINTENANCE

that become apparent in the works under normal use for the duration of re-occur throughout all planted, mulched and paved areas. The Provide, in accordance with AS 4454, well rotted vegetative material or the contract Defects Liability Period. The Landscape Contractor shall contractor shall target weeds that are capable of producing a major animal manure, free from harmful chemicals, grass and weed growth. maintain the contract areas by the implementation of industry accepted infestation of unwanted plants by seed distribution. Whenever horticultural practices for 52 weeks. The landscape maintenance works possible, time weed removal to precede flowering and seed set shall include, but not be limited to, the following: • Replacing failed plants;

Maintenance Program

	Ŭ								
	Activity	Frequency							Action
		D	W	2W	3W	М	ЗM	6M	
1	Logbook	+		+		+			Complete a logbook entry every day at site and at least every two weeks. All actions listed below require a logbook entry. Upon request, make the logbook available for inspection. Submit copies of new entries in the logbook to the Contract Administrator on a monthly basis. Please note that more frequent, short, occasional inspection should result in less maintenance work when problems are observed earlier than they might otherwise have been seen.
2	Plant Replacement			+		+			Inspect and replace failed plants within 2 weeks of observation of failure. Match species, size (original) and location of new with old.
3	Mulch			+		+			Inspect and replace mulch deficiencies within 2 weeks of observation. Prior to placing new mulch aerate the soil by fork turning to a depth of at least 100mm, roughly level the soil and then place mulch. Do not disturb major plant roots while aerating soil.
4	Erosion Control			+					Inspect every two weeks and repair ground, soil and mulch immediately. Maintain erosion control device as necessary.
5	Stakes and ties			+					Inspect every two weeks, adjust and/or replace as necessary but remove as plants mature and are able to support themselves.
6	Weed and Rubbish removal			+					Inspect and remove immediately upon observation. Leave no waste on site. Dispose of waste material at a designated waste disposal site
7	Pruning			+					Inspect every 2 weeks and prune as necessary to remove dead wood, improve plant shape and promote healthy vigorous new growth.
8	Spraying			+					Inspect every 2 weeks and action as necessary. Do not spray if other non-chemical methods will satisfy the need to remove insects. Spray for disease control only when absolutely necessary.
9	Urgent Works		+						Complete within 1 week (7 days) of notification. Inspect and clear drains.
10	Planting and fertilising			+			+		Inspect every 2 weeks and remove spent flowers and dead stalks as they become apparent. Fertilise gardens every 3 months or other frequency in accordance with fertiliser manufacturer's directions.
11	Watering	+		+					Water when and where necessary every day at site and at least every 2 weeks generally. Do not allow soil and plants to dehydrate. Allow for prolonged rain, windy and dry periods. Water in the early morning or late afternoon to avoid excessive evaporation during the heat of the day.
12	Mowing, top dressing and edging			+		+		+	Summer fortnightly. Winter monthly. Top-dress 6 monthly.

 Fertilising; Stakes and ties;

Maintenance Log Book

Insect and pest control;

Immediately report to the Project Manager any evidence of intensive weed infestation, insect attack or disease amongst plant material. Submit all proposals to apply chemicals and obtain approval before Mulch shall be approved recycled wood fibre or pine bark mulch. Place starting this work. When approved, spray with herbicide, insecticide, fungicide as appropriate in accordance with the manufacturers' recommendations. Record in the logbook all relevant details of spraying activities including:

Date of application and location. Stakes and ties - Adjust and replace as required to ensure irrigation controller self operated via a soil moisture sensor. The system plants remain correctly staked. Remove those not required at the end of the planting establishment period (Defects Liability Period). • **Maintaining mulch** - Maintain the surface in a clean, tidy and weed free condition and reinstate the mulch as necessary to ensure

necessary

© 2016 Site Image (NSW) Pty Ltd ABN 44 801 262 380 as agent for Site Image NSW Partnership. All rights reserved. This drawing is copyright and shall not be reproduced or copied in any form or by any means (graphic, electronic or mechanical including photocopy) without the written permission of Site Image (NSW) Pty Ltd Any license, expressed or implied, to use this document for any purpose what so ever is restricted to the terms of the written agreement between Site Image (NSW) Pty Ltd and the instructing party.

The contractor shall check and verify all work on site (including work by others) before commencing the landscape installation. Any discrepancies are to be reported to the Project Manager or Landscape Architect prior to commencing work. Do not scale this drawing. Any required dimensions not shown shall be referred to the Landscape Architect for confirmation.

 Maintaining mulch; Mowing and top dressing; Erosion control; and • Weeding and rubbish removal.

Implement and keep a maintenance log book recording when and what maintenance work has been undertaken and what materials, actions and decisions have been used, implemented and concluded to keep the landscape always looking its best.

Maintenance Activities

Schedule the following activities to occur on a timely basis.

Plant replacement - Replace plants that have failed to mature, die or are damaged. Replacement plants shall be in a similar size and quality and identical species or variety to the plant that has failed. Replacement of plants shall be at the cost of the landscape contractor unless advised otherwise. If the cause of the failure is due to a controllable situation then correct the situation prior to replacing

• **Pruning** - Prune dead wood, broken limbs, dead or infected foliage and as needed to develop strong, healthy plants to achieve the shape and form expected of the plant type.

Insect and pest control - Avoid spraying:

 if ever possible; o in wet weather or if wet weather is imminent;

if target plants are still wet after rain; in windy weather; and

if non-target species are too close.

• Product brand / manufacturer's name,

Chemical / product name,

Chemical contents, Application quantity and rate,

Date of application and location,

Results of application, and

Use approval authority.

Fertilising - Fertilise gardens with a proprietary slow release fertiliser applied in accordance with the manufacturer's directions and recommendations. Record in the logbook all relevant details of

fertilising including:

 Product brand / manufacturer's name, Fertiliser / product name,

Application quantity and rate, and


• Irrigation and watering - Maintain the irrigation system to sure that each individual plant receives the required amount of water to Provide additional watering, if necessary.

• **Erosion control** - Where necessary, maintain the erosion control devices in a tidy and weed free condition and reinstate as necessary to ensure control measures are effective where deemed

• Weeding and rubbish removal - During the plant establishment The Landscape Contractor shall rectify defects during installation and period remove by hand, rubbish and weed growth that may occur or

JM NM 02.02.2021 Architectural Coordination Architectural Coordination JM NM 13.11.2020 Architectural Coordination JM NM 24.09.2020 Updated Civil Drawings SM NM 30.03.2020 Architectural Coordination JM NM 25.03.2020 A For Review JM NM 17.02.2020 Issue Revision Description Drawn Check Date

LEGEND

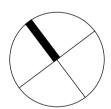

Client: Fabcot Pty Ltd

Project: Woolworths Leppington 116 Ingleburn Road, Leppington

Level 1, 3-5 Baptist Street Redfern NSW 2016 Australia

Tel: (61 2) 8332 5600 Fax: (61 2) 9698 2877 www.siteimage.com.au Site Image (NSW) Pty Ltd

ABN 44 801 262 380



Landscape Architects

DEVELOPMENT APPLICATION

Drawing Name:

Landscape Specification

Scale: As Shown Job Number:

SS20-4303

504